
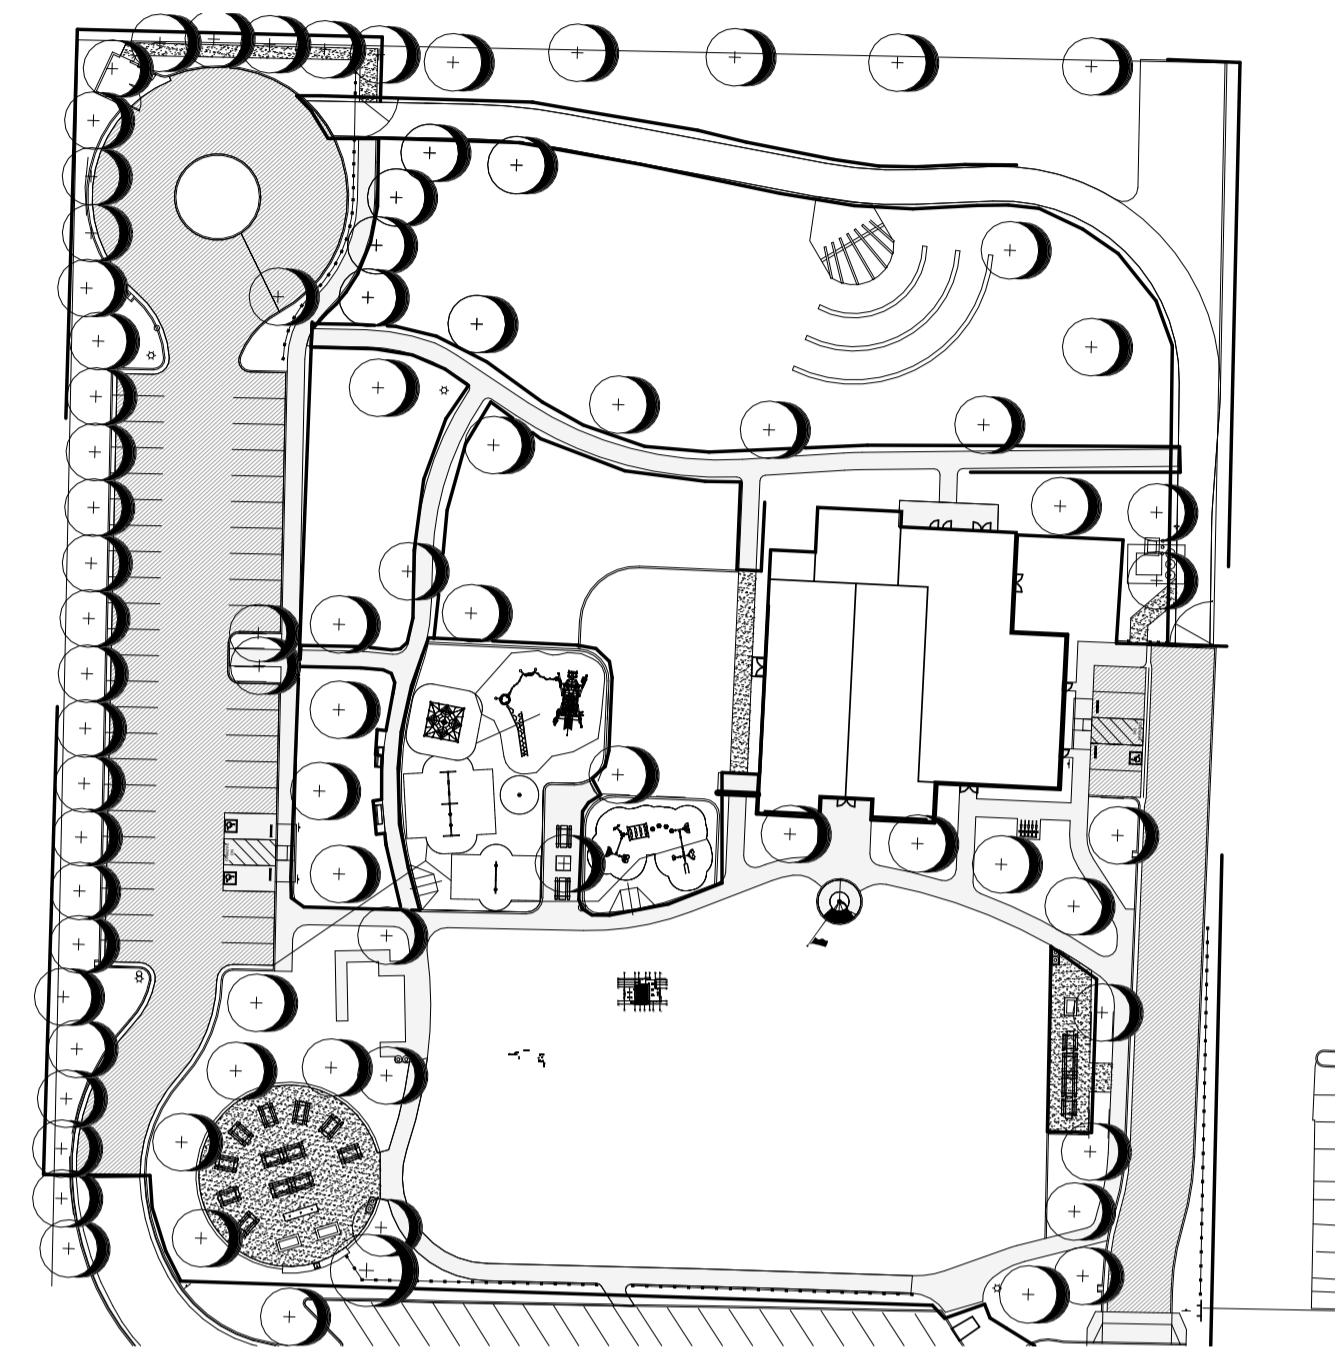


# GUADALUPE LEROY PARK PARKING LOT UPGRADE

4689 11TH STREET  
GUADALUPE, CALIFORNIA 93434

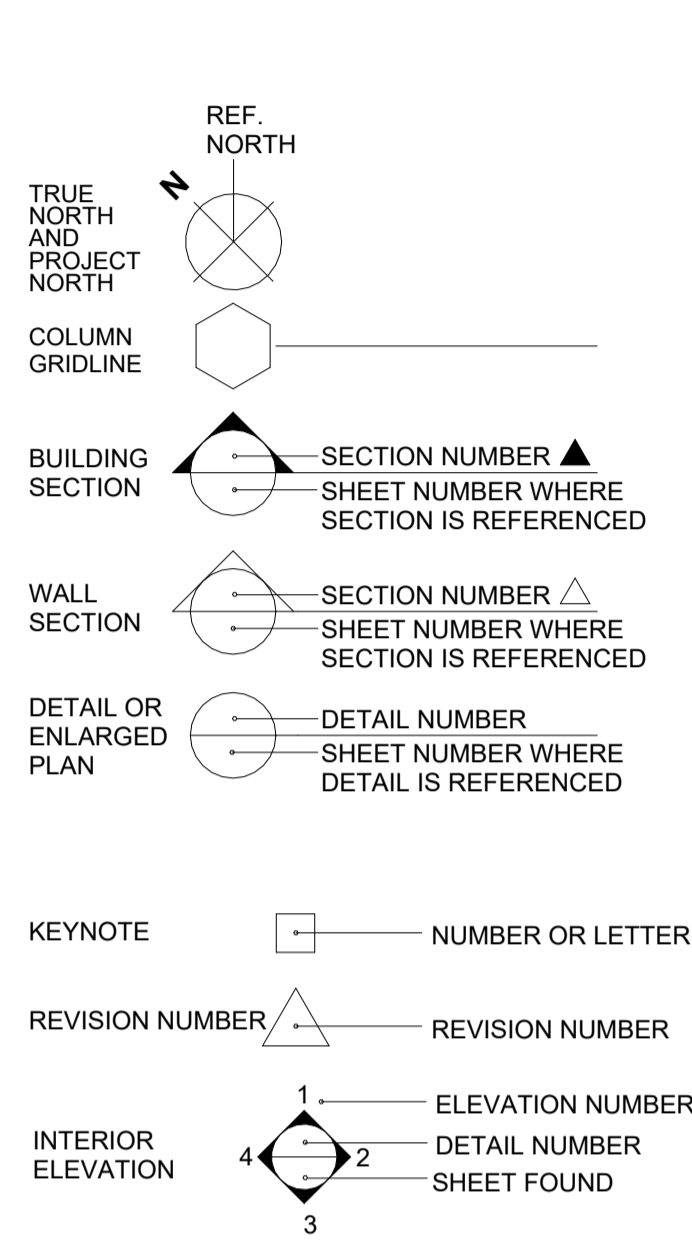


**SHEET INDEX**

Sheet Number	Sheet Name	Sheet Issue Date	Current Rev	Current Rev Date
G0.0	TITLE SHEET	03/29/2024		
A1.1	PROPOSED SITE PLAN	10/23/2024		
C-1.0	GENERAL NOTES	03/29/24		
C-2.0	HORIZONTAL CONTROL	03/29/24		
C-3.0	GRADING AND DRAINAGE PLAN	03/29/24		
C-3.1	GRADING AND DRAINAGE PLAN	03/29/24		
C-4.0	EROSION CONTROL	03/29/24		
C-4.1	EROSION CONTROL DETAILS	03/29/24		

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**REVISIONS**  
REV # | REV DATE | REV DESCRIPTION

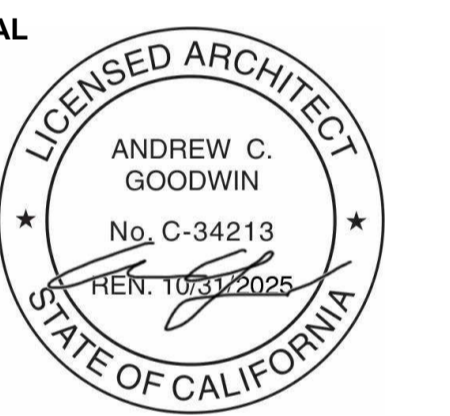

**PROJECT**  
GUADALUPE LEROY PARK  
PARKING LOT UPGRADE  
4689 11TH STREET  
GUADALUPE,  
CALIFORNIA 93434  
**CLIENT**  
CITY OF GUADALUPE

- 51 SYMBOLS**
- DO NOT SCALE PLANS.
  - ALL CONSTRUCTION SHALL CONFORM WITH TITLE 24 AND THE 2022 CBC, CMC, CPC, AND 2022 CEC AMENDMENTS AND CITY OF GUADALUPE MUNICIPAL CODE.
  - ALL DIMENSIONS ARE TO BE VERIFIED IN THE FIELD. ANY DISCREPANCIES ARE TO BE IMMEDIATELY BROUGHT TO THE ATTENTION OF THE ARCHITECT. DO NOT PROCEED WITHOUT RESOLVING DISCREPANCIES.
  - DIMENSIONS SHOWN SHALL TAKE PRECEDENCE OVER DRAWINGS SCALE OR PROPORTION. LARGER SCALE DRAWINGS TAKE PRECEDENCE OVER SMALLER SCALE DRAWINGS.
  - REQUIRED SANITARY FACILITIES SHALL BE PROVIDED ON THE JOB.
  - OMISSIONS AND/OR CONFLICTS IN THE DRAWINGS SHALL NOT RELIEVE THE CONTRACTOR FROM COMPLETING WORK WHICH IS NECESSARY TO CARRY OUT THE INTENT OF THE DRAWING AND/OR COMPLETE WORK TO STANDARDS REQUIRED BY CODE.
  - THESE NOTES INDICATE CONSTRUCTION FOR PROPOSED BUILDING UNLESS OTHERWISE NOTED OR SHOWN. FEATURES OF CONSTRUCTION SHOWN ARE TYPICAL AND SHALL APPLY TO ALL DRAWINGS UNLESS OTHERWISE NOTED OR SHOWN. FEATURES OF CONSTRUCTION SHOWN ARE TYPICAL AND SHALL APPLY GENERALLY THROUGHOUT TO SIMILAR CONDITIONS, UNLESS NOTED OTHERWISE ALL VESTIBULES, CLOSETS, COLUMNS PROJECTIONS, RECESSES, OR OTHER ADJACENT AREAS WITHIN SCHEDULED AREAS SHALL HAVE FINISHES AS SCHEDULED FOR THE RESPECTIVE SPACES IN WHICH THEY OCCUR. ALL OMISSIONS OR CONFLICTS BETWEEN THE VARIOUS ELEMENTS OF THE WORKING DRAWINGS AND/OR GENERAL NOTES SHALL BE BROUGHT TO THE ATTENTION OF THE OWNER BEFORE PROCEEDING WITH ANY WORK SO INVOLVED.
  - ALL WORK, AND ALL CONSTRUCTION METHODS AND MATERIALS SHALL COMPLY WITH ALL PROVISIONS OF THE BUILDING CODES AND OTHER RULES, REGULATIONS AND ORDINANCES GOVERNING THE PLACE OF THE BUILDING. BUILDING CODE REQUIREMENTS IN ALL CASES TAKE PRECEDENCE OVER THE DRAWING. IT SHALL BE THE RESPONSIBILITY OF ANYONE SUPPLYING LABOR OR MATERIALS OR BOTH TO BRING TO THE ATTENTION OF THE ARCHITECT ANY DISCREPANCIES OR CONFLICTS BETWEEN THE REQUIREMENTS OF THE CODE AND THE DRAWINGS.
  - UNLESS NOTED OTHERWISE, ALL DIMENSIONS ARE TO INTERIOR FINISH FACE.
  - CONTRACTOR SHALL ARRANGE AND PAY FOR ALL TEMPORARY UTILITY SERVICES AND CONNECTIONS DURING CONSTRUCTION.
  - ANY CHANGES IN CONSTRUCTION SHALL BE ACCOMPANIED BY A CHANGE ORDER ISSUED BY THE GENERAL CONTRACTOR AND APPROVED BY THE OWNER.
  - THE CONTRACT DRAWINGS AND SPECIFICATIONS REPRESENT THE FINISHED IMPROVEMENTS. UNLESS OTHERWISE SHOWN, THEY DO NOT INDICATE METHOD OF CONSTRUCTION. CONTRACTOR SHALL SUPERVISE AND DIRECT WORK AND SHALL BE SOLELY RESPONSIBLE FOR ALL CONSTRUCTION MEANS, METHODS, TECHNIQUES, SEQUENCES AND PROCEDURES. OBSERVATION VISITS TO THE SITE SHALL NOT INCLUDE INSPECTIONS OF THE PROTECTIVE MEASURES OR THE CONSTRUCTION PROCEDURES REQUIRED FOR SAME, WHICH ARE THE SOLE RESPONSIBILITY OF THE CONTRACTOR.
  - CONTRACTOR HEREBY GUARANTEES TO THE OWNER THAT ALL MATERIALS, FIXTURES, AND EQUIPMENT FURNISHED TO THE PROJECT ARE NEW UNLESS OTHERWISE SPECIFIED.
  - ANYONE SUPPLYING LABOR AND/OR MATERIALS TO THE PROJECT SHALL CAREFULLY EXAMINE ALL SUBSURFACES TO RECEIVE WORK. ANY CONDITIONS DETRIMENTAL TO WORK SHALL BE REPORTED TO THE ARCHITECT/OWNER COMMENCEMENT OF WORK SHALL IMPLY ACCEPTANCE OF ALL SUBSURFACES.
  - ANY MATERIAL STORED AT THE SITE SHALL BE COMPLETELY SUPPORTED FREE OF THE GROUND, COVERED AND OTHERWISE PROTECTED TO AVOID DAMAGE.
  - PRIOR TO FINAL INSPECTION AS A DEFERRED SUBMITTAL ITEM, PROVIDE A FINAL COPY OF BUILDING OPERATION AND MAINTENANCE MANUAL TO BUILDING INSPECTOR. CAL GREEN 5.408, 5.410, 5.504, 5.1
  - ANY DAMAGE, AS A RESULT OF CONSTRUCTION OPERATIONS FOR THIS PROJECT, TO CITY FACILITIES, I.E. CURB/BERM, STREET, SEWER LINE, WATER LINE, OR ANY PUBLIC IMPROVEMENTS SHALL BE REPAIRED AT NO COST TO THE DISTRICT.

- 41 PARKING LOT**  
1: 7400
- THIS PROJECT MUST COMPLY WITH THE LATEST APPLICABLE CODE WHICH HAVE BEEN ADOPTED BY THE GOVERNING AGENCIES HAVING JURISDICTION, INCLUDING BUT NOT LIMITED TO THE FOLLOWING:
- 2022 CALIFORNIA BUILDING CODE, VOLS 1 & 2
  - 2022 CALIFORNIA ELECTRICAL CODE
  - 2022 CALIFORNIA MECHANICAL CODE
  - 2022 CALIFORNIA PLUMBING CODE
  - 2022 CALIFORNIA ENERGY CODE
  - 2022 CALIFORNIA FIRE CODE
  - 2022 CALIFORNIA GREEN BUILDING CODE
  - 2022 CALIFORNIA REFERENCE STANDARDS CODE
- THESE CODES SHALL BE CONSIDERED AN INTEGRAL PART OF THESE DRAWINGS AS IF THEY WERE PRINTED HERE ON THIS SHEET IN THEIR ENTIRETY.

- 42 APPLICABLE CODES**
- CONTRACTOR SHALL VERIFY EXISTING CONDITIONS AT THE PROJECT SITE AS DESCRIBED IN THE CONTRACT DOCUMENTS PRIOR TO STARTING WORK. IF THERE IS ANY DISCREPANCY BETWEEN THE DRAWINGS AND THE EXISTING CONDITIONS, THE ARCHITECT SHALL BE NOTIFIED IMMEDIATELY.
  - PREVENT DEBRIS FROM BEING DEPOSITED ON ADJACENT AREAS, WALKWAYS, AND STREETS.
  - CAP ALL ABANDONED UTILITIES BELOW FLOOR, ABOVE CEILING OR AS INDICATED ON DRAWINGS.
  - ALL EQUIPMENT TO BE REMOVED WILL BE SAVED FOR THE OWNER'S INSPECTION TO DETERMINE IF NEEDED. THE CONTRACTOR SHALL BE RESPONSIBLE FOR DISPOSAL OF ALL ITEMS NOT USABLE.
  - PROVIDE SEISMIC RESTRAINTS FOR ALL PLUMBING, ELECTRICAL, MECHANICAL, AND FIRE SUPPRESSION SYSTEMS.
  - CONTRACTOR SHALL FURNISH MATERIAL, EQUIPMENT AND LABOR TO PATCH THE FLOOR AND REPAIR THE WALL AND CEILING TO MATCH THE ADJACENT EXISTING SURFACES AFTER INSTALLATION AND INSPECTION AS APPROVED.
  - THE CONTRACTOR SHALL BE RESPONSIBLE FOR CONTINUOUS CLEAN UP OF THE SITE OF ALL DEBRIS, WHETHER CREATED BY HIS WORK OR THE FAILURE OF HIS SUBCONTRACTORS TO CLEAN UP THEIR WORK.
  - ALL LIFE/ SAFETY EQUIPMENT DISTURBED BY NEW CONSTRUCTION SHALL BE REINSTALLED.
  - CONTRACTOR TO PATCH ALL DISTURBED SURFACES TO MATCH EXISTING ADJACENT SURFACES.
  - CONTRACTOR SHALL BE RESPONSIBLE FOR ALL WORK RELATED TO AND REQUIRED BY THE INSTALLATION OF NEW CONSTRUCTION. CONTRACTOR TO DETERMINE SIZE AND INSTALLATION METHOD OF NEW SYSTEMS. ALL WORK TO BE OF TOP QUALITY.
  - EXISTING UTILITIES SHALL BE MAINTAINED IN SERVICE THROUGHOUT THE WORK. ANY UTILITY SHUT-DOWN SHALL BE SCHEDULED A MINIMUM OF 48 HRS IN ADVANCE IN WRITING. ANY UTILITY SERVICE THAT IS DAMAGED SHALL BE PUT BACK IN SERVICE IMMEDIATELY AT NO ADDITIONAL COST TO THE OWNER.
  - IT IS THE RESPONSIBILITY OF THE CONTRACTOR TO ENSURE THAT NO EMERGENCY EXIT IS BLOCKED AT ANY TIME.
  - CONTRACTOR SHALL MINIMIZE NOISE AND CONGESTION AS MUCH AS POSSIBLE DURING DEMOLITION.
  - DISCONNECTION OF AND/OR RELOCATION OF EXISTING PLUMBING, ELECTRICAL, MECHANICAL, AND FIRE SUPPRESSION EQUIPMENT SHALL BE DONE AT SUCH TIMES THAT OPERATIONS OF THE EXISTING FACILITY WILL BE UNAFFECTED.

**OWNER:**  
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**ARCHITECT:**  
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**CIVIL:**  
-

**32 PROJECT DIRECTORY**

**OVERALL PROJECT:**  
WEST PARKING LOT PAVING UPGRADE



REQUIRED PERMITTING PER THIS CONSTRUCTION DOCUMENT SET:  
BUILDING PERMIT

**54 GENERAL NOTES**

**44 DEMO NOTES**

**34 VICINITY MAP**

**14 REQUIRED PERMITTING**


**SHEET TITLE**  
TITLE SHEET

**DATE:** 03/29/2024

**TECHNICIAN:** RT

**PROJECT MANAGER:** MD

**JOB NUMBER:** 827  
SHEET NUMBER  
**G0.0**

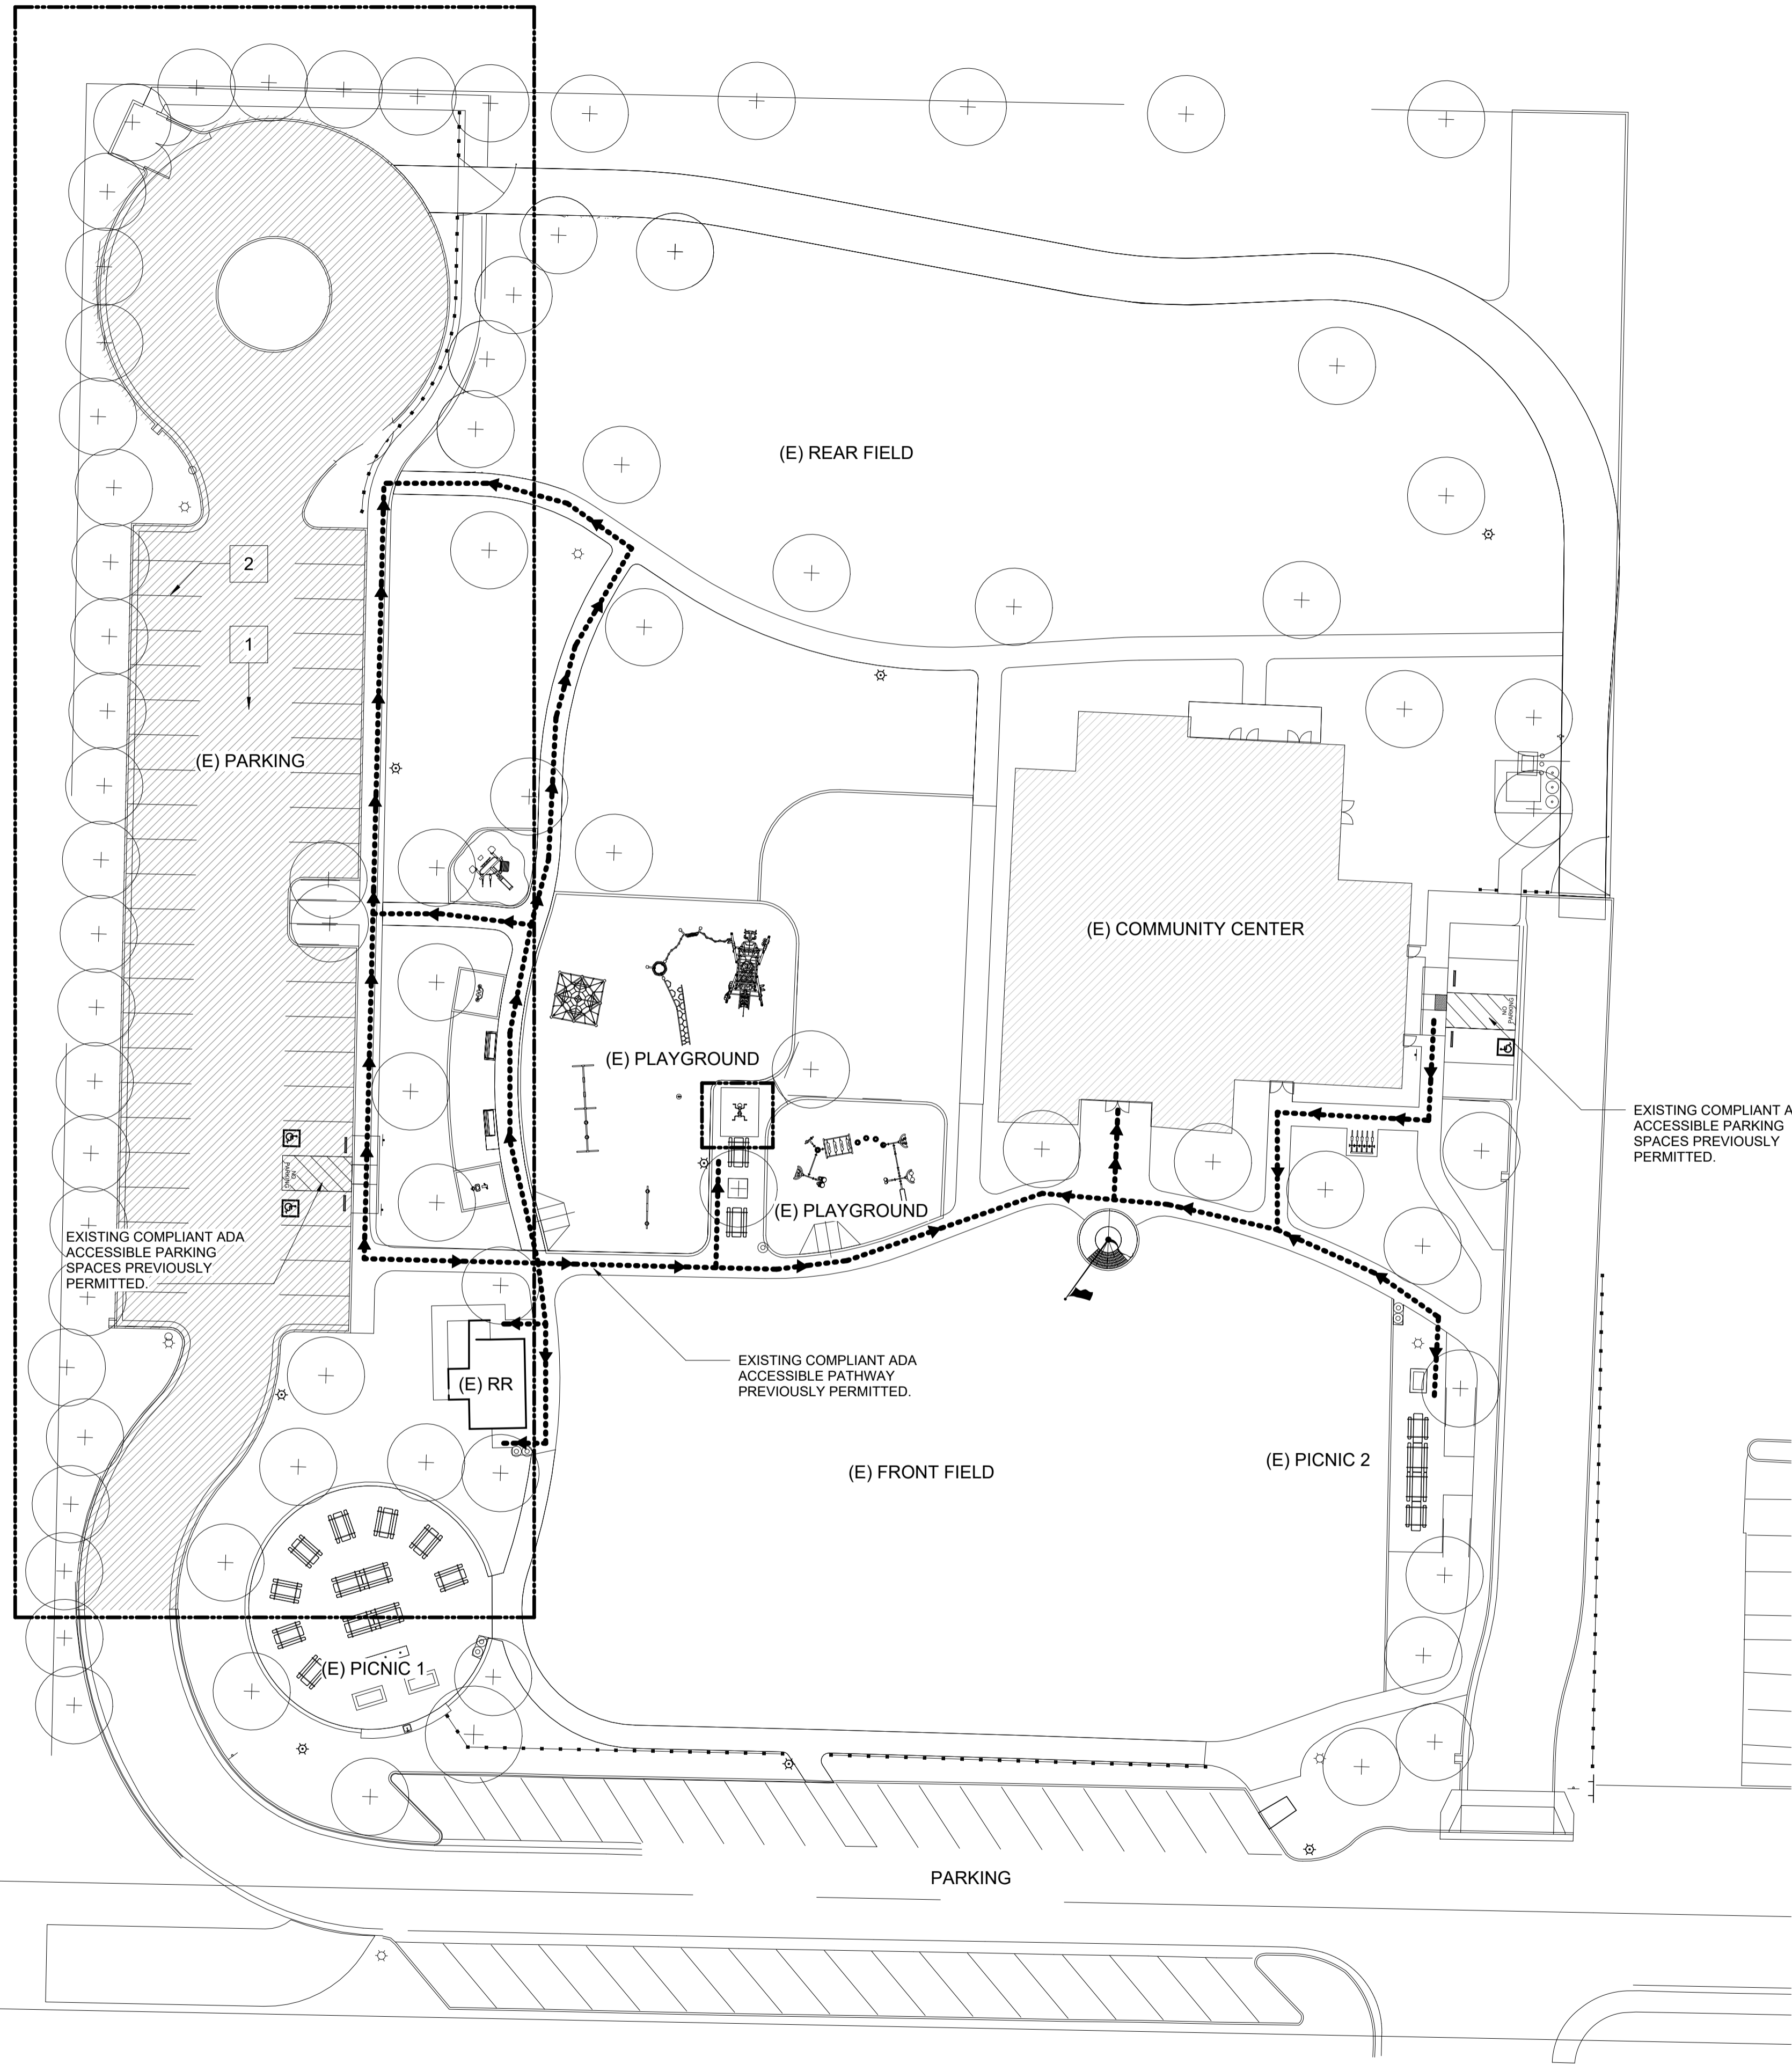

**44** PROPOSED SITE PLAN  
 1/16" = 1'-0"

KEYNOTES: SITE PLAN	
1.	NEW ASPHALT PAVED PARKING LOT PER CIVIL DRAWINGS.
2.	PROVIDE 4" WHITE PARKING SPACE STRIPING PER CIVIL DRAWINGS.

GENERAL NOTES: SITE PLAN	
1.	ALL EXISTING EXTERIOR DIMENSIONS ARE APPROXIMATE. CONTRACTOR TO VERIFY IN FIELD.
2.	INFORMATION PERTAINING TO EXISTING UNDERGROUND FACILITIES AS SHOWN HEREIN IS FOR INFORMATION PURPOSES ONLY. UTILITIES SHOWN IN PLAN VIEW MAY NOT BE SHOWN IN PROFILE. IT SHALL BE THE RESPONSIBILITY OF THE CONTRACTOR TO CONTACT "UNDERGROUND SERVICES ALERT" AT 1-800-642-2444 FOR LOCATION OF ALL UNDERGROUND FACILITIES. ALL UNDERGROUND UTILITIES SHOWN ON THESE PLANS WERE DELINEATED BASED ON THE BEST AS-BUILT INFORMATION AVAILABLE AT THE TIME. THE CONTRACTOR SHALL BE RESPONSIBLE TO VERIFY THE ACTUAL LOCATIONS OF THE CABLE TV, FIBER OPTIC, WATER, SEWER, DRAINAGE, OR OTHER UNDERGROUND FACILITIES IN THE FIELD PRIOR TO CONSTRUCTION AND SHALL NOTIFY THE ENGINEER IMMEDIATELY IN THE EVENT THAT POTENTIAL CONFLICTS OR INTERFACES ARE DISCOVERED.
3.	ALL UTILITY COMPANIES MUST BE INFORMED PRIOR TO CONSTRUCTION.
4.	CONTRACTOR SHALL BE RESPONSIBLE FOR THE PREVENTION OF WIND EROSION AND DUST WITHIN THE AREAS OF OPERATION. METHOD OF CONTROL SHALL BE SELECTED BY THE CONTRACTOR BUT SHALL SATISFY REQUIREMENTS.
5.	ACCESS AISLES SHALL BE MARKED WITH A BLUE PAINTED BORDERLINE AROUND THEIR PERIMETER. THE AREA WITHIN THE BLUE BORDERLINES SHALL BE MARKED WITH HATCHED LINES A MAXIMUM OF 36 INCHES ON CENTER IN A COLOR CONTRASTING THAT OF THE AISLE SURFACE, PREFERABLY BLUE OR WHITE. THE WORDS "NO PARKING" SHALL BE PAINTED ON THE SURFACE WITHIN EACH ACCESS AISLE IN WHITE LETTER A MINIMUM OF 12 INCHES IN HEIGHT AND LOCATED TO BE VISIBLE FROM THE ADJACENT VEHICULAR WAY. ACCESS AISLE MARKINGS MAY EXTEND BEYOND THE MINIMUM REQUIRED LENGTH. (CBC SECTION 11B-502.3.3)
6.	ACCESSIBLE PARKING SPACE AND ACCESS AISLE NOT TO EXCEED 2% SLOPE IN ANY DIRECTION.
7.	PROVIDE A 2% SLOPE AWAYS FROM THE PROPOSED BUILDING FOR A MINIMUM OF FIVE FEET.
8.	ALL EXTERIOR LIGHTS SHALL NOT TRESPASS ONTO ADJACENT PROPERTY OR PUBLIC RIGHT-OF-WAY.

SIGNS SHALL NOT PROJECT OVER PUBLIC PROPERTY, VEHICULAR EASMENTS, OR RIGHT-OF-WAY. SIGNS SHALL NOT OBSTRUCT TRAFFICE SAFETY SIGHT AREAS.

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REVISIONS		
REV #	REV DATE	REV DESCRIPTION



GENERAL NOTES: CONCRETE WASHOUT	
<b>DESCRIPTION:</b>	PREVENT OR REDUCE THE DISCHARGE OF POLLUTANTS TO STORM WATER FROM CONCRETE WASTE BY CONDUCTING WASHOUT OFF-SITE, PERFORMING ON-SITE WASHOUT IN A DESIGNATED AREA, AND TRAINING EMPLOYEES AND SUBCONTRACTORS.
<b>APPROACH:</b>	THE FOLLOWING STEPS WILL HELP REDUCE STORM WATER POLLUTION FROM CONCRETE WASTES:
	- STORE DRY AND WET MATERIALS UNDER COVER, AWAY FROM DRAINAGE AREAS.
	- AVOID MIXING EXCESS AMOUNTS OF FRESH CONCRETE OR CEMENT ON-SITE.
	- PERFORM WASHOUT OF CONCRETE TRUCKS OFF SITE OR IN DESIGNATED AREAS ONLY.
	- DO NOT WASH OUT CONCRETE TRUCKS INTO STORM DRAINS, OPEN DITCHES, STREETS, OR STREAMS.
	- DO NOT ALLOW EXCESS CONCRETE TO BE DUMPED ON-SITE, EXCEPT IN DESIGNATED AREAS.
	- FOR ON-SITE WASHOUT:
	-- LOCATE WASHOUT AREA AT LEAST FIFTY FEET (50') FROM STORM DRAINS, OPEN DITCHES, OR WATER BODIES. DO NOT ALLOW RUNOFF FROM THIS AREA BY CONSTRUCTING A TEMPORARY PIT OR BERMED AREA LARGE ENOUGH FOR LIQUID AND SOLID WASTE.
	-- WASH OUT WASTES INTO THE TEMPORARY PIT WHERE THE CONCRETE CAN SET, BE BROKEN UP, AND THEN DISPOSED OF PROPERLY.
	- WHEN WASHING CONCRETE TO REMOVE FINE PARTICLES AND EXPOSE THE AGGREGATE, AVOID CREATING RUNOFF BY DRAINING THE WATER TO THE BERMED OR LEVEL AREA.
	- DO NOT WASH SWEEPINGS FROM EXPOSED AGGREGATE CONCRETE INTO THE STREET OR STORM DRAIN. COLLECT AND RETURN SWEEPINGS TO AGGREGATE BASE STOCK PILE, OR DISPOSE IN THE TRASH.

**PROJECT**  
 GUADALUPE LEROY PARK  
 PARKING LOT UPGRADE  
 4689 11TH STREET  
 GUADALUPE, CALIFORNIA  
 93434

**CLIENT**  
 CITY OF GUADALUPE

LEGEND: SITE	
	EXISTING BUILDING
	SCOPE OF WORK

**SHEET TITLE**  
 PROPOSED SITE PLAN

**DATE:** 10/23/2024

**TECHNICIAN:** JDM


**PROJECT MANAGER:** MD


**JOB NUMBER:** 827  
 SHEET NUMBER

A1.1





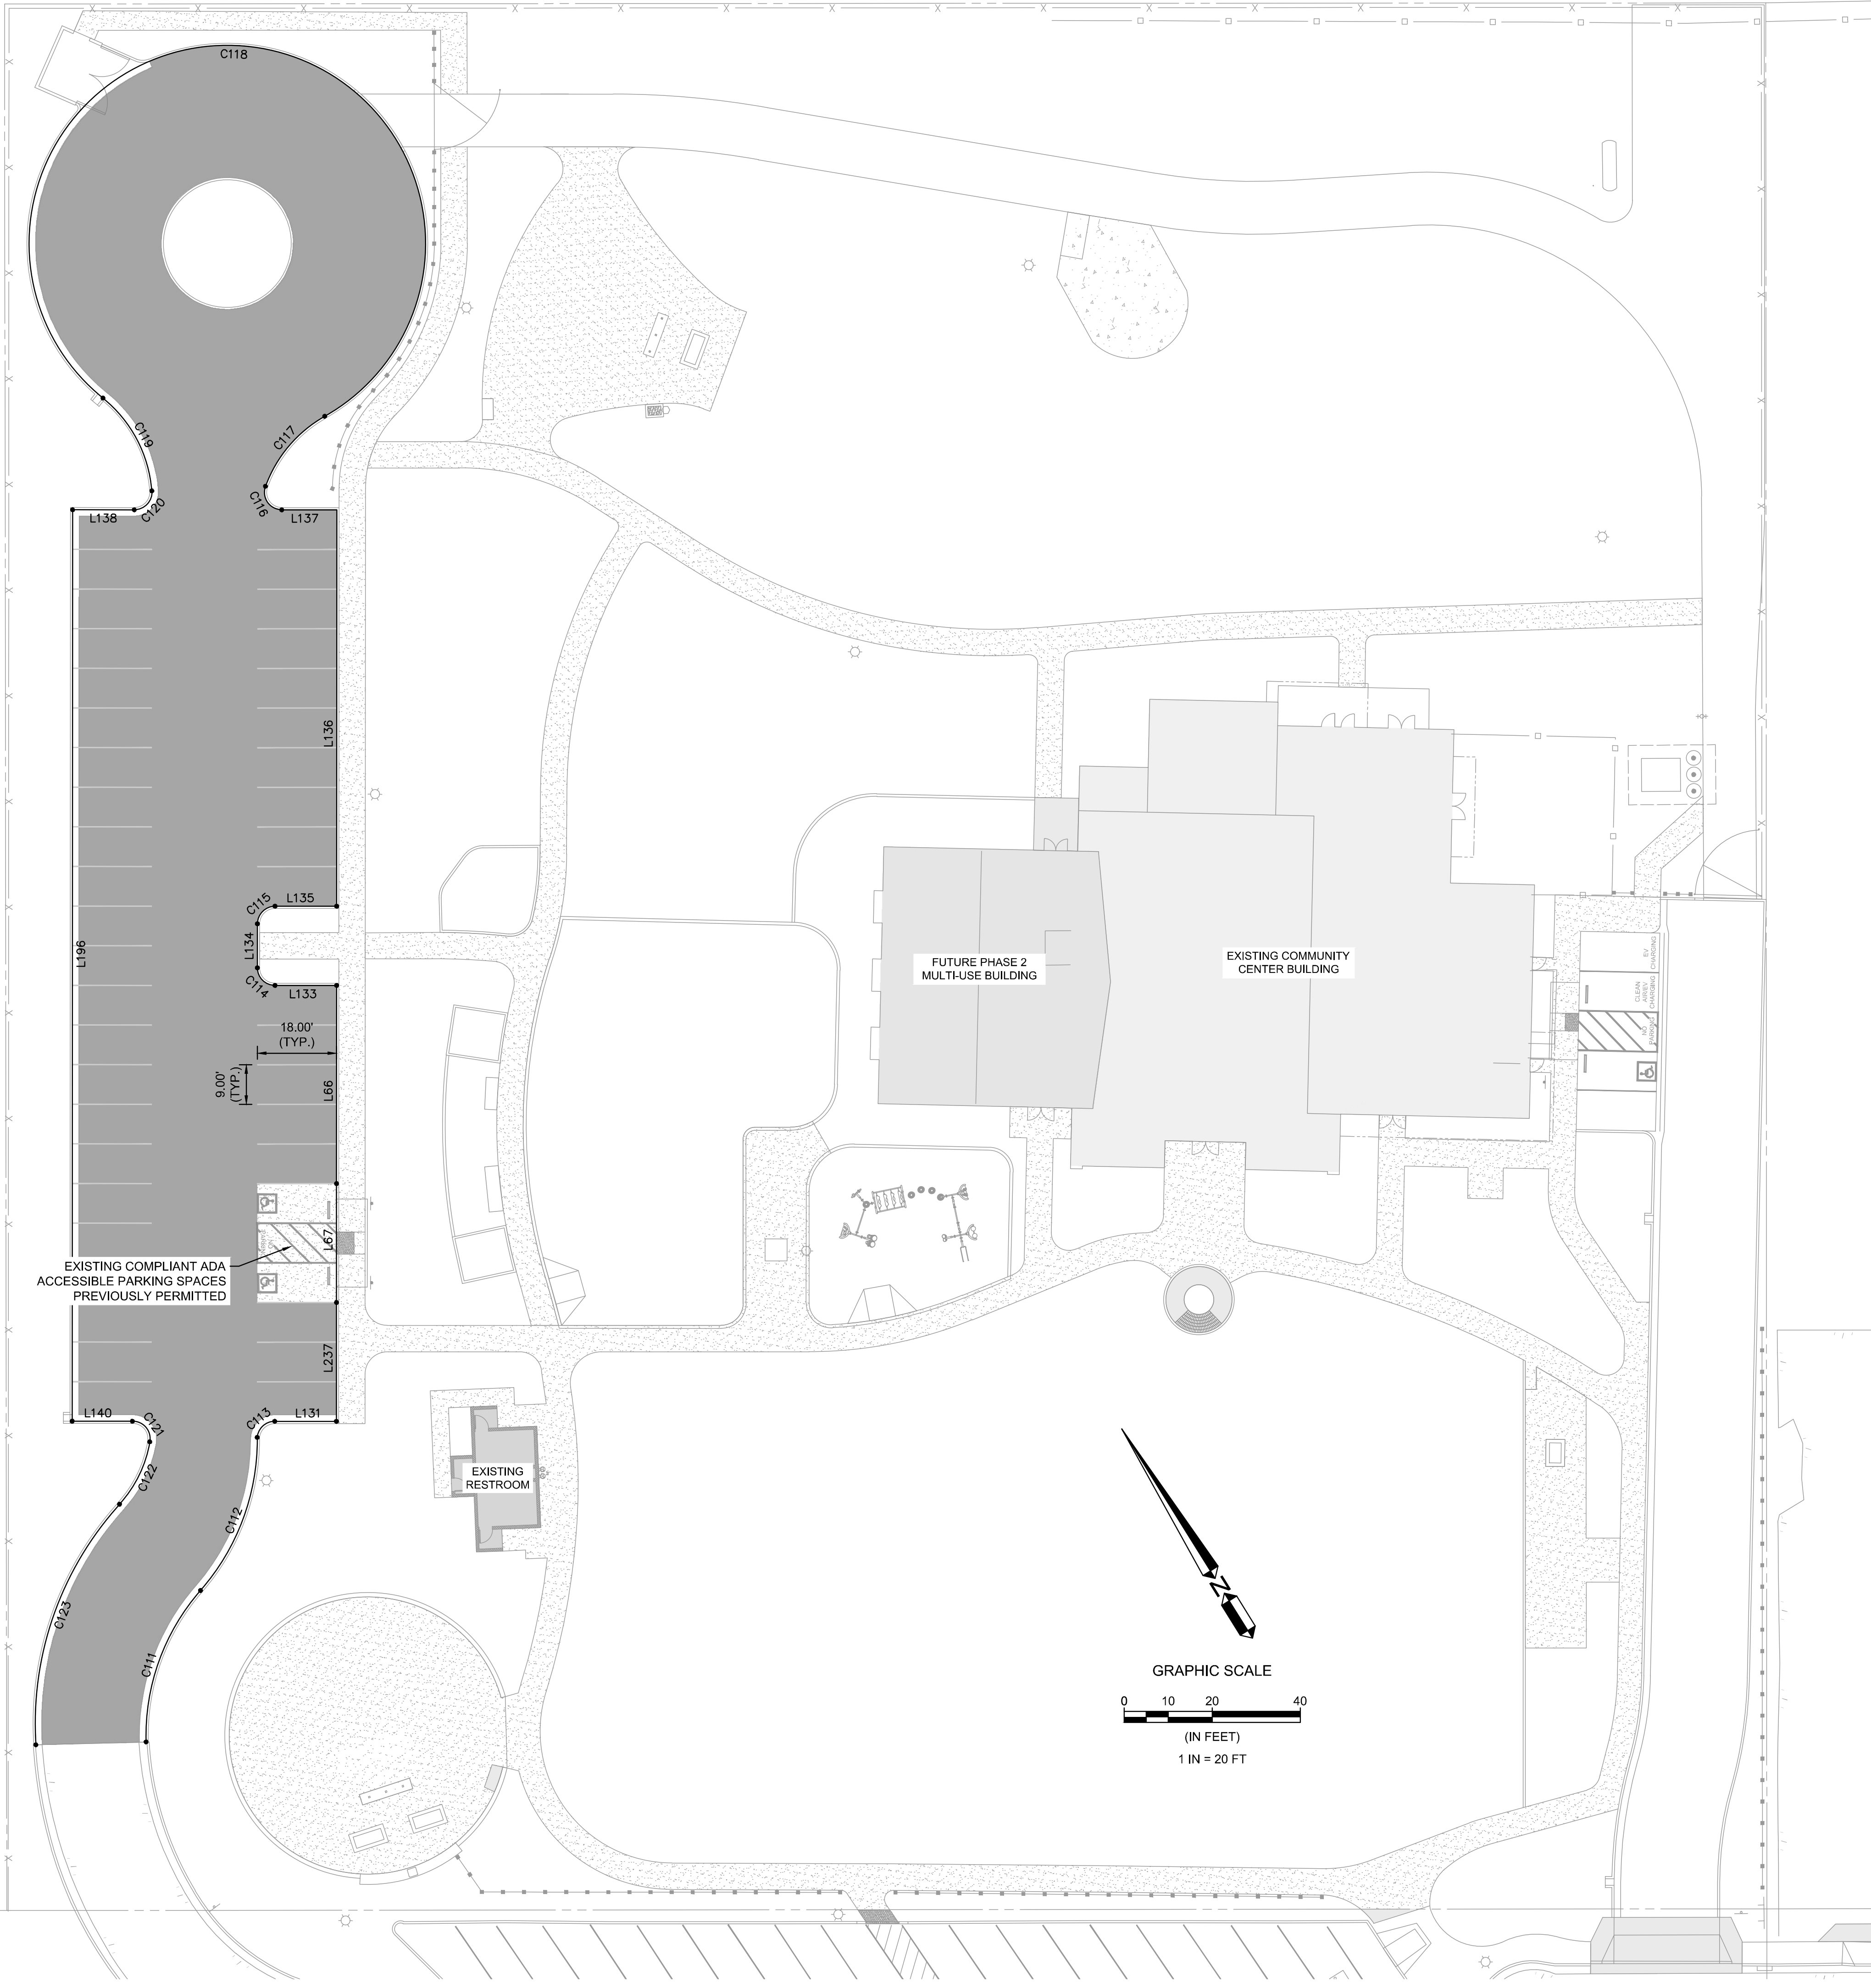

LEGEND:  
 ASPHALT


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L66	45.00	S28°59'48"W
L67	27.00	S28°59'48"W
L131	14.00	S61°00'12"E
L133	14.00	N61°00'12"W
L134	10.00	N28°59'48"E
L135	14.00	S61°00'12"E
L136	90.00	N28°59'48"E
L137	12.45	N61°00'12"W
L138	13.77	N61°00'12"W
L140	13.67	S61°00'12"E
L196	207.00	S28°59'48"W
L237	27.00	S28°59'48"W

Curve Table			
Curve #	Length	Radius	Delta
C111	37.42	50.00	42°52'37"
C112	37.53	52.00	41°21'15"
C113	6.29	4.00	90°04'39"
C114	6.28	4.00	90°00'00"
C115	6.28	4.00	90°00'00"
C116	7.61	4.00	108°58'01"
C117	21.26	30.00	40°36'18"
C118	229.13	45.00	291°42'43"
C119	24.48	29.99	46°45'34"
C120	6.59	4.00	94°26'47"
C121	6.94	4.00	99°27'27"
C122	15.98	28.00	32°42'05"
C123	59.41	74.00	46°00'06"



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REVISIONS


SEAL

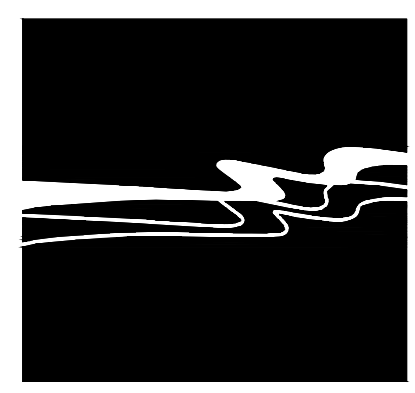

DATE: 10/25/2024

PROJECT  
 GUADALUPE LEROY PARK  
 PARKING LOT UPGRADE

4689 11TH STREET  
 GUADALUPE,  
 CALIFORNIA 93434

CLIENT  
 CITY OF GUADALUPE

SHEET TITLE  
 HORIZONTAL  
 CONTROL


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TECHNICIAN: CPK

PROJECT MANAGER: BDH

JOB NUMBER: 827

SHEET NUMBER  
 C-2.0

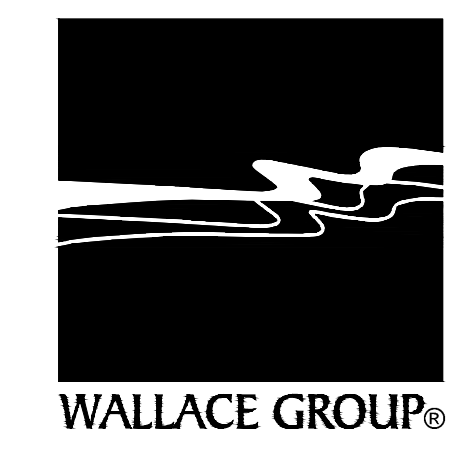

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PROJECT  
GUADALUPE LEROY PARK  
PARKING LOT UPGRADE

4689 11TH STREET  
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CALIFORNIA 93434

CLIENT  
CITY OF GUADALUPE

SHEET TITLE  
GRADING AND DRAINAGE  
PLAN

DATE: 10/25/2024


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PROJECT MANAGER: BDH




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SHEET NUMBER  
C-3.0

REFERENCE KEYNOTES	
STORMWATER	
100	EXISTING CURB, PROTECT IN PLACE. ASPHALT PAVEMENT TO CONFORM AT FLOWLINE
101	EXISTING BIORETENTION AREA PER PHASE 1 PLANS, PROTECT IN PLACE
102	EXISTING CURB AND GUTTER WITH CURB CUTS, PROTECT IN PLACE. ASPHALT PAVEMENT TO CONFORM AT GUTTER LIP
103	EXISTING CONCRETE CURB AND SIDEWALK, PROTECT IN PLACE
104	EXISTING TRASH ENCLOSURE, PROTECT IN PLACE
105	PREPARE EXIST CLASS 2 BASE PARKING LOT FOR PAVING, REMOVE TOP LAYER OF BASE TO ALLOW FOR 3" OF ASPHALT, GRADE AS SHOWN ON PLANS AND COMPACT BASE MATERIAL (MIN 9" BASE DEPTH) TO 95% RELATIVE COMPACTION PER GEOTECHNICAL REPORT. SEE PAVEMENT SECTION, DETAIL A, SHEET C-3.0
106	PARKING SPACE PAVEMENT MARKINGS, 18' x 9' TYPICAL PARKING SPACE, WHITE PAINT (2-COAT) PER CITY OF SANTA MARIA SPECIFICATIONS
107	EXISTING CONCRETE ACCESSIBLE PARKING SPACES, PROTECT IN PLACE AND CONFORM AT EDGE OF EXISTING CONCRETE
108	EXISTING CURB RAMP, PROTECT IN PLACE
109	EXISTING FENCE, PROTECT IN PLACE
110	EXISTING CATCH BASIN, PROTECT IN PLACE
111	EXISTING CONCRETE PATH, PROTECT IN PLACE
112	CONFORM TO EXISTING ASPHALT PAVING



**A** ASPHALT SECTION  
Scale: NTS

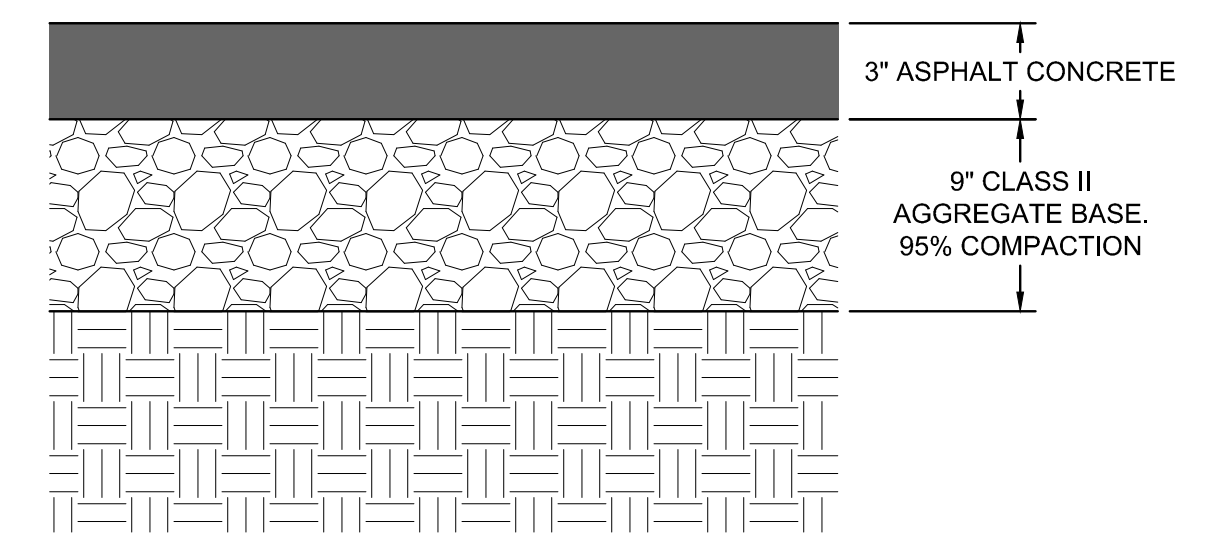

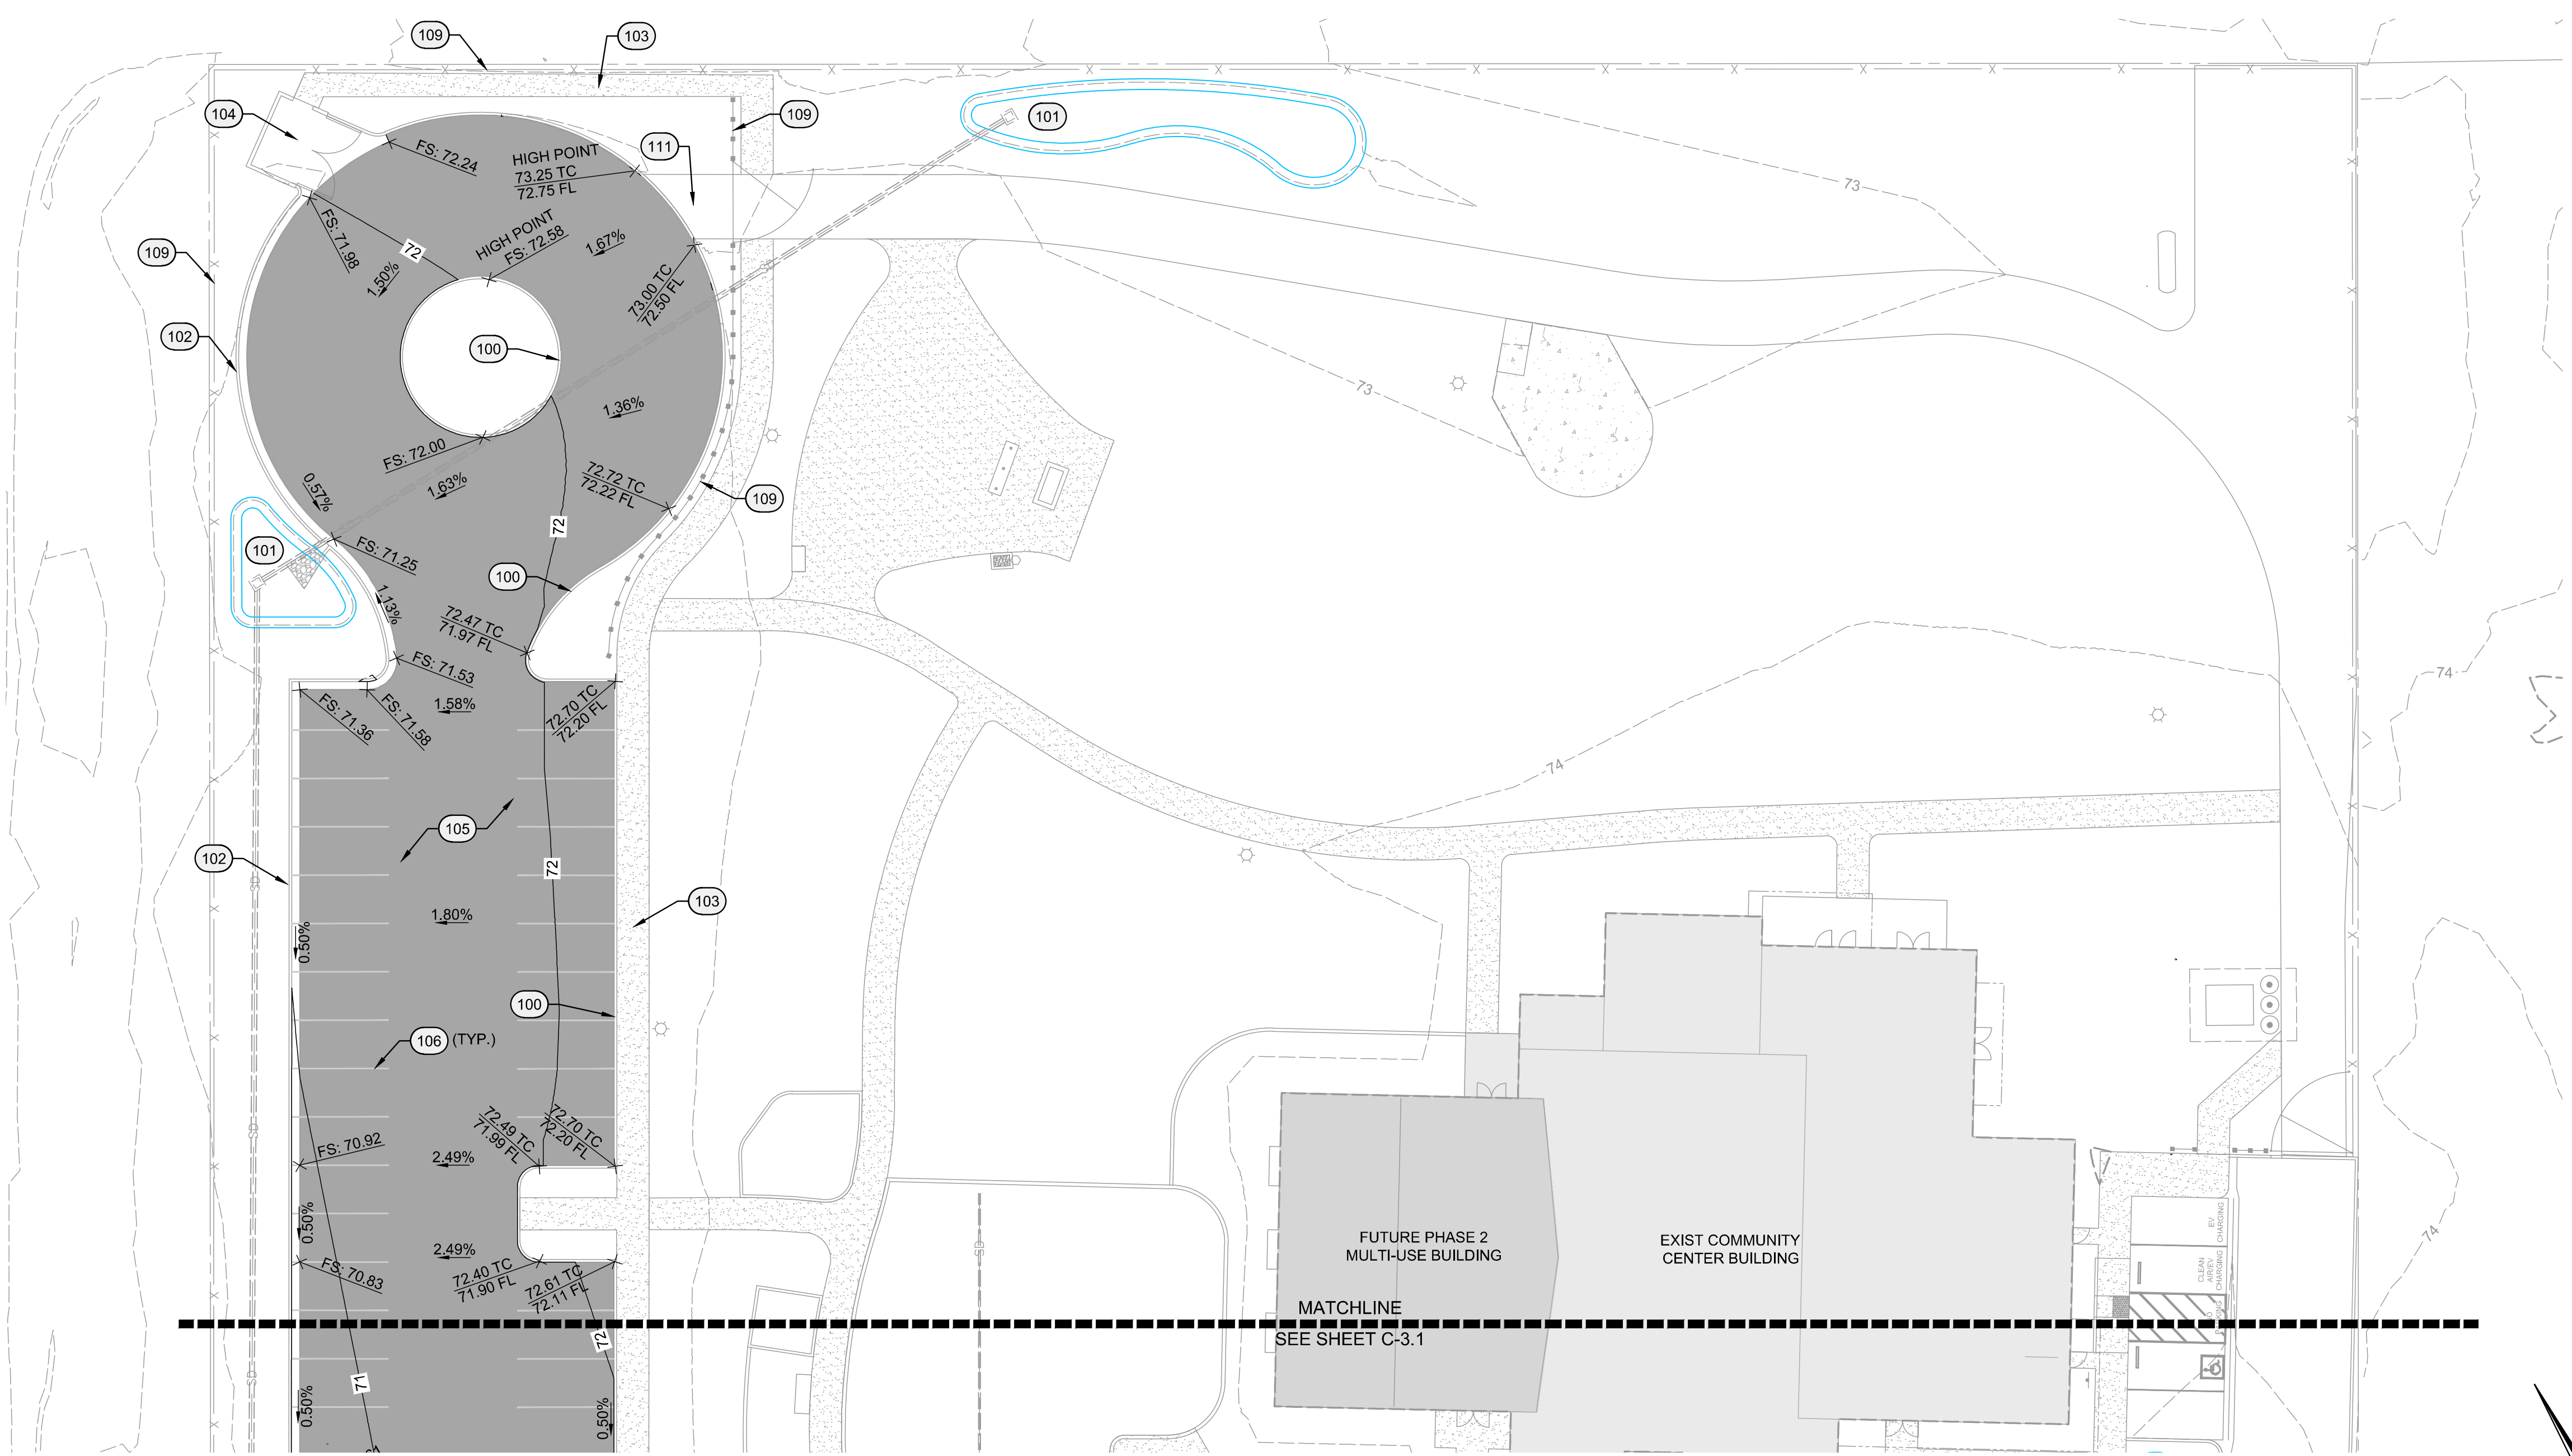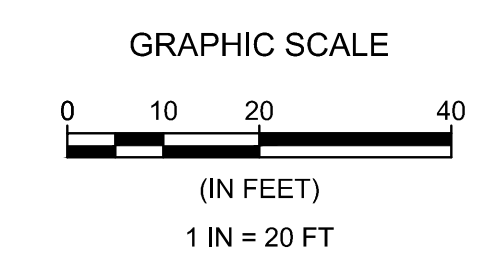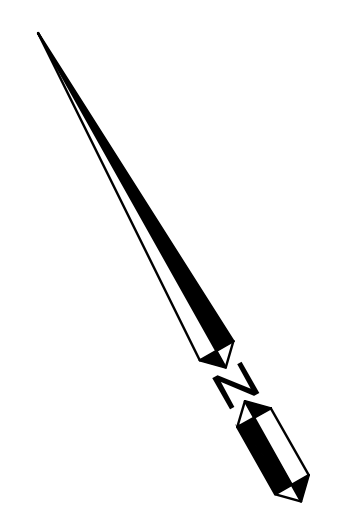

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REVISIONS


SEAL

DATE: 10/25/2024

PROJECT  
**GUADALUPE LEROY PARK  
 PARKING LOT UPGRADE**

4689 11TH STREET  
 GUADALUPE,  
 CALIFORNIA 93434

CLIENT  
**CITY OF GUADALUPE**


SHEET TITLE  
**GRADING AND DRAINAGE  
 PLAN**

DATE: 10/25/2024

TECHNICIAN: CPK


PROJECT MANAGER: BDH

JOB NUMBER: 827  
 SHEET NUMBER:  
**C-3.1**

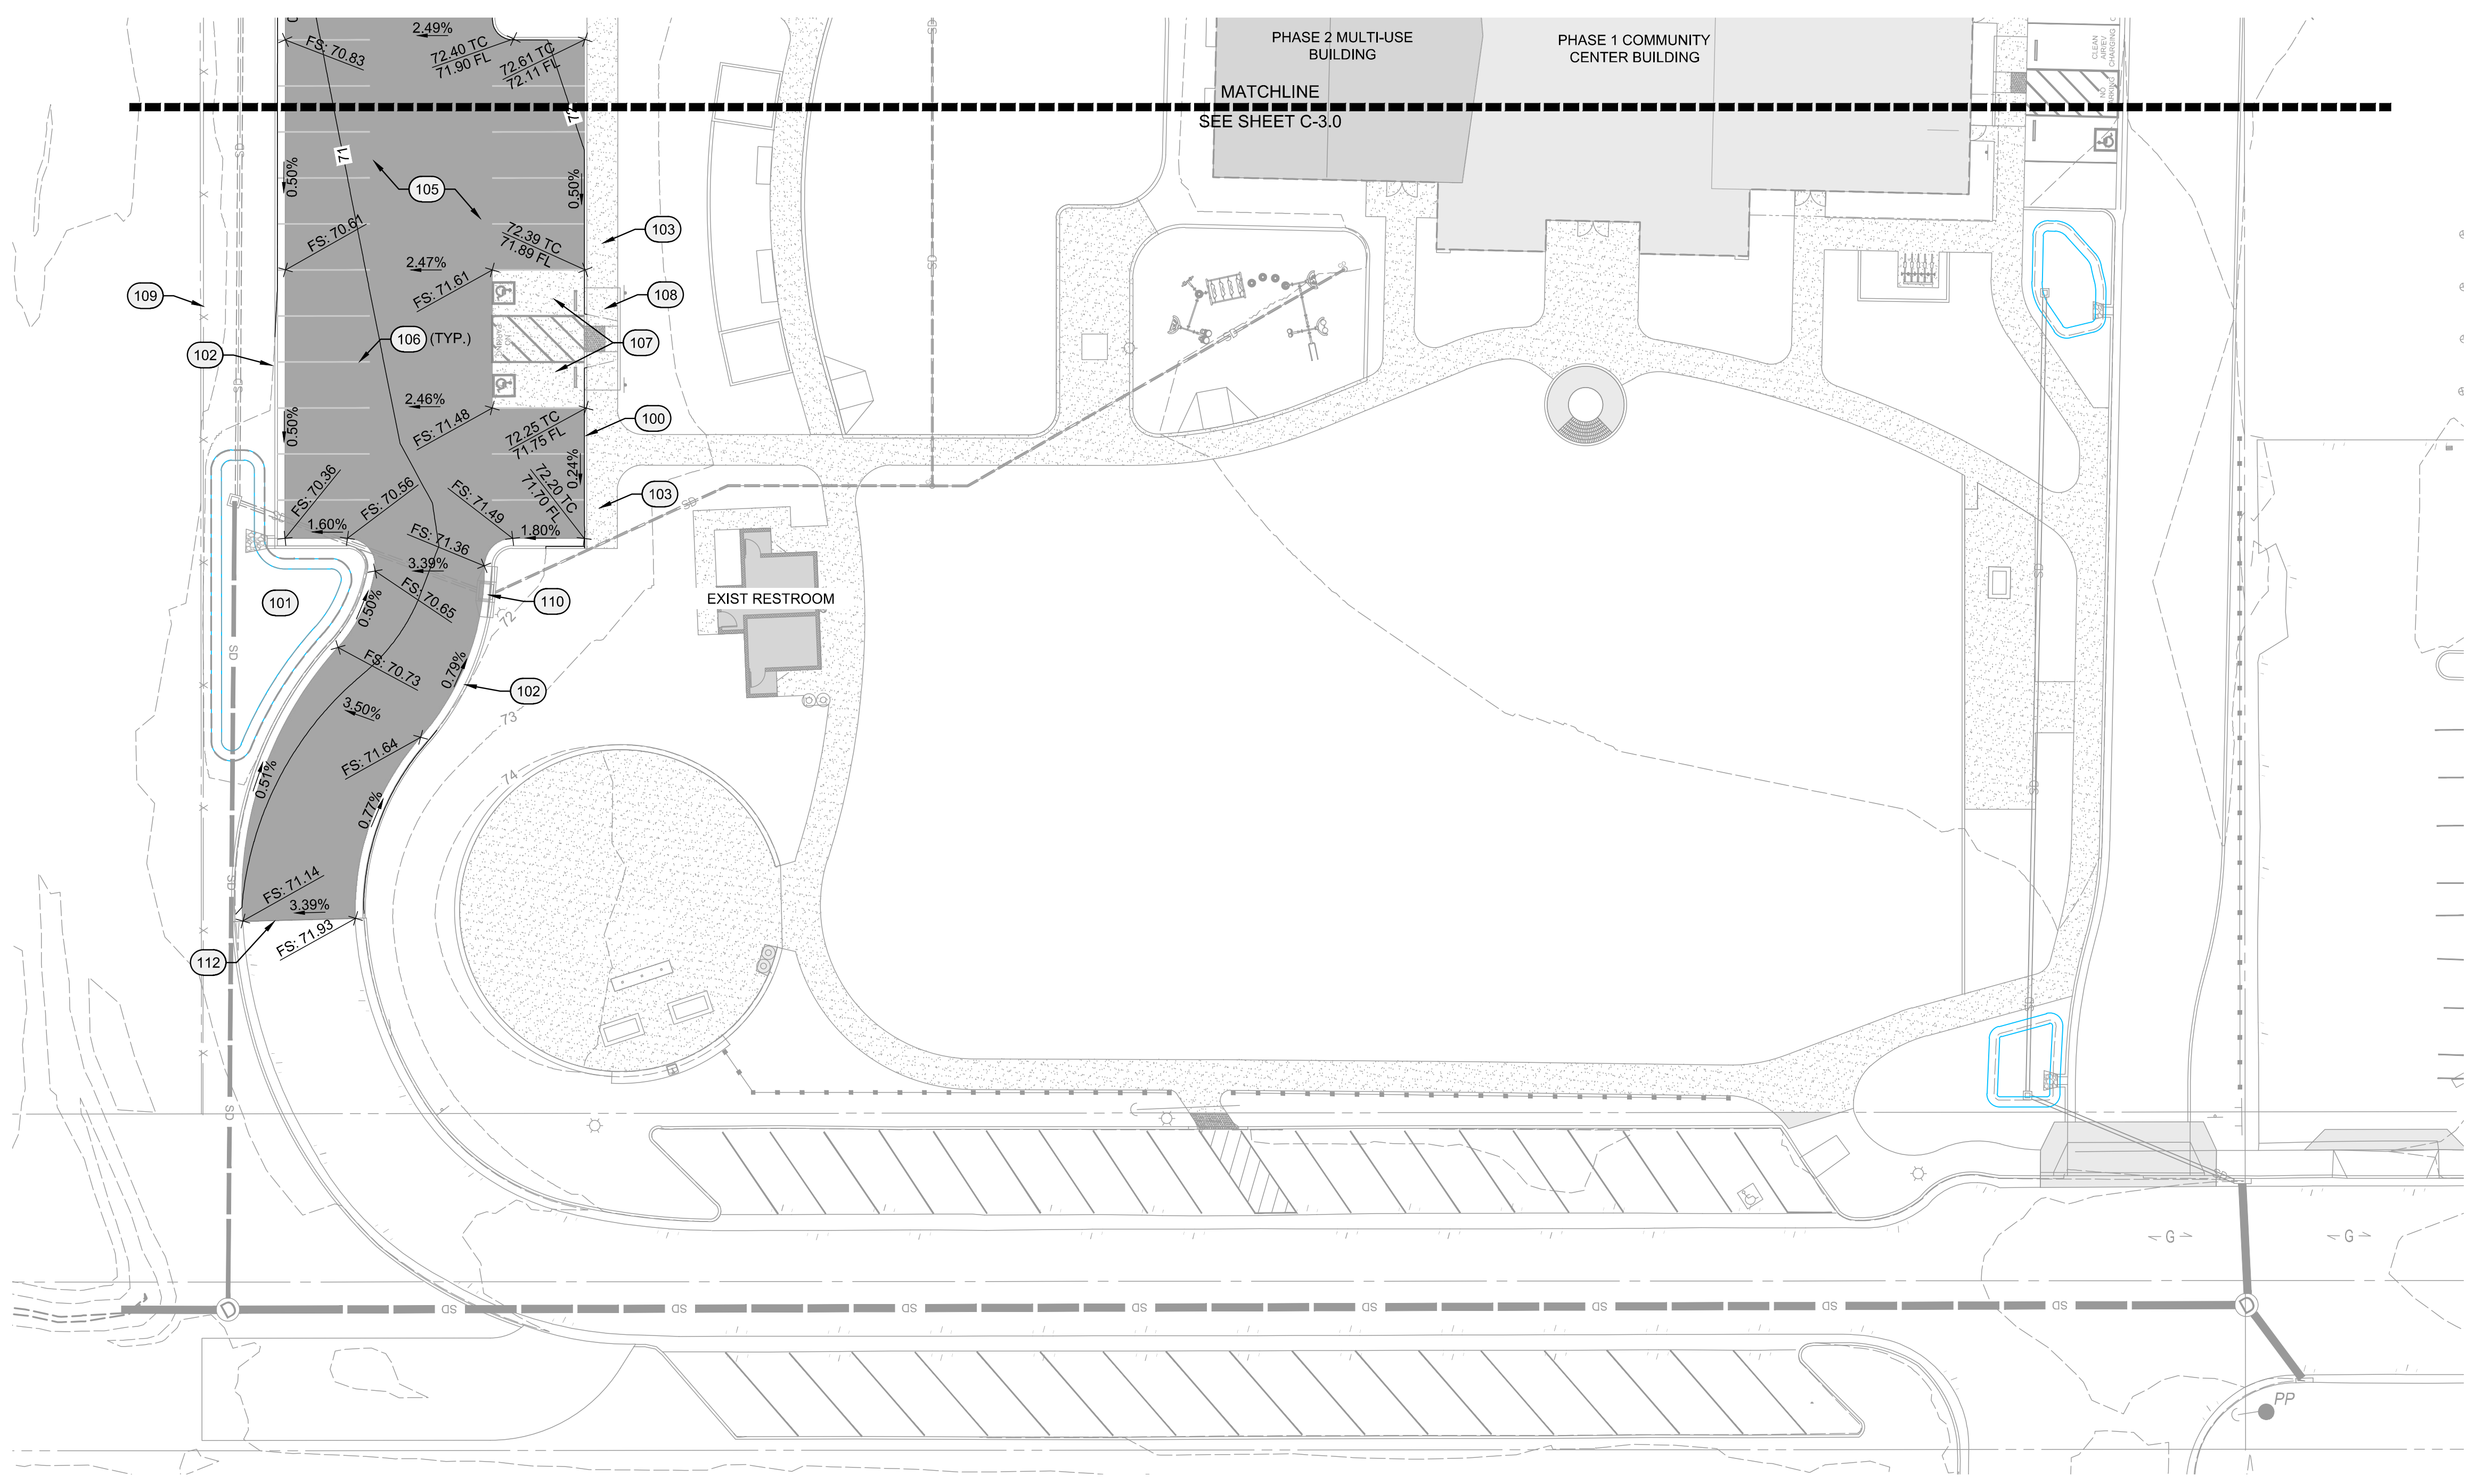
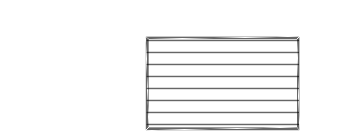
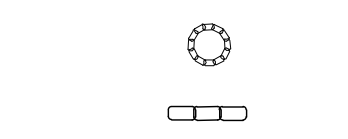
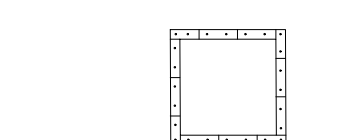
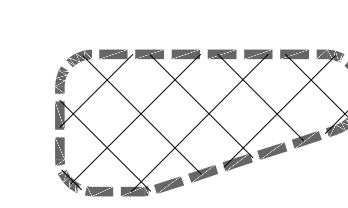




**REFERENCE KEYNOTES**

STORMWATER	
100	EXISTING CURB, PROTECT IN PLACE. ASPHALT PAVEMENT TO CONFORM AT FLOWLINE
101	EXISTING BIORETENTION AREA PER PHASE 1 PLANS, PROTECT IN PLACE
102	EXISTING CURB AND GUTTER WITH CURB CUTS, PROTECT IN PLACE. ASPHALT PAVEMENT TO CONFORM AT GUTTER LIP
103	EXISTING CONCRETE CURB AND SIDEWALK, PROTECT IN PLACE
104	EXISTING TRASH ENCLOSURE, PROTECT IN PLACE
105	PREPARE EXIST CLASS 2 BASE PARKING LOT FOR PAVING, REMOVE TOP LAYER OF BASE TO ALLOW FOR 3" OF ASPHALT, GRADE AS SHOWN ON PLANS AND COMPACT BASE MATERIAL (MIN 9" BASE DEPTH) TO 95% RELATIVE COMPACTION PER GEOTECHNICAL REPORT. SEE PAVEMENT SECTION, DETAIL A, SHEET C-3.0
106	PARKING SPACE PAVEMENT MARKINGS, 18' x 9' TYPICAL PARKING SPACE, WHITE PAINT (2-COAT) PER CITY OF SANTA MARIA SPECIFICATIONS
107	EXISTING CONCRETE ACCESSIBLE PARKING SPACES, PROTECT IN PLACE AND CONFORM AT EDGE OF EXISTING CONCRETE
108	EXISTING CURB RAMP, PROTECT IN PLACE
109	EXISTING FENCE, PROTECT IN PLACE
110	EXISTING CATCH BASIN, PROTECT IN PLACE
111	EXISTING CONCRETE PATH, PROTECT IN PLACE
112	CONFORM TO EXISTING ASPHALT PAVING

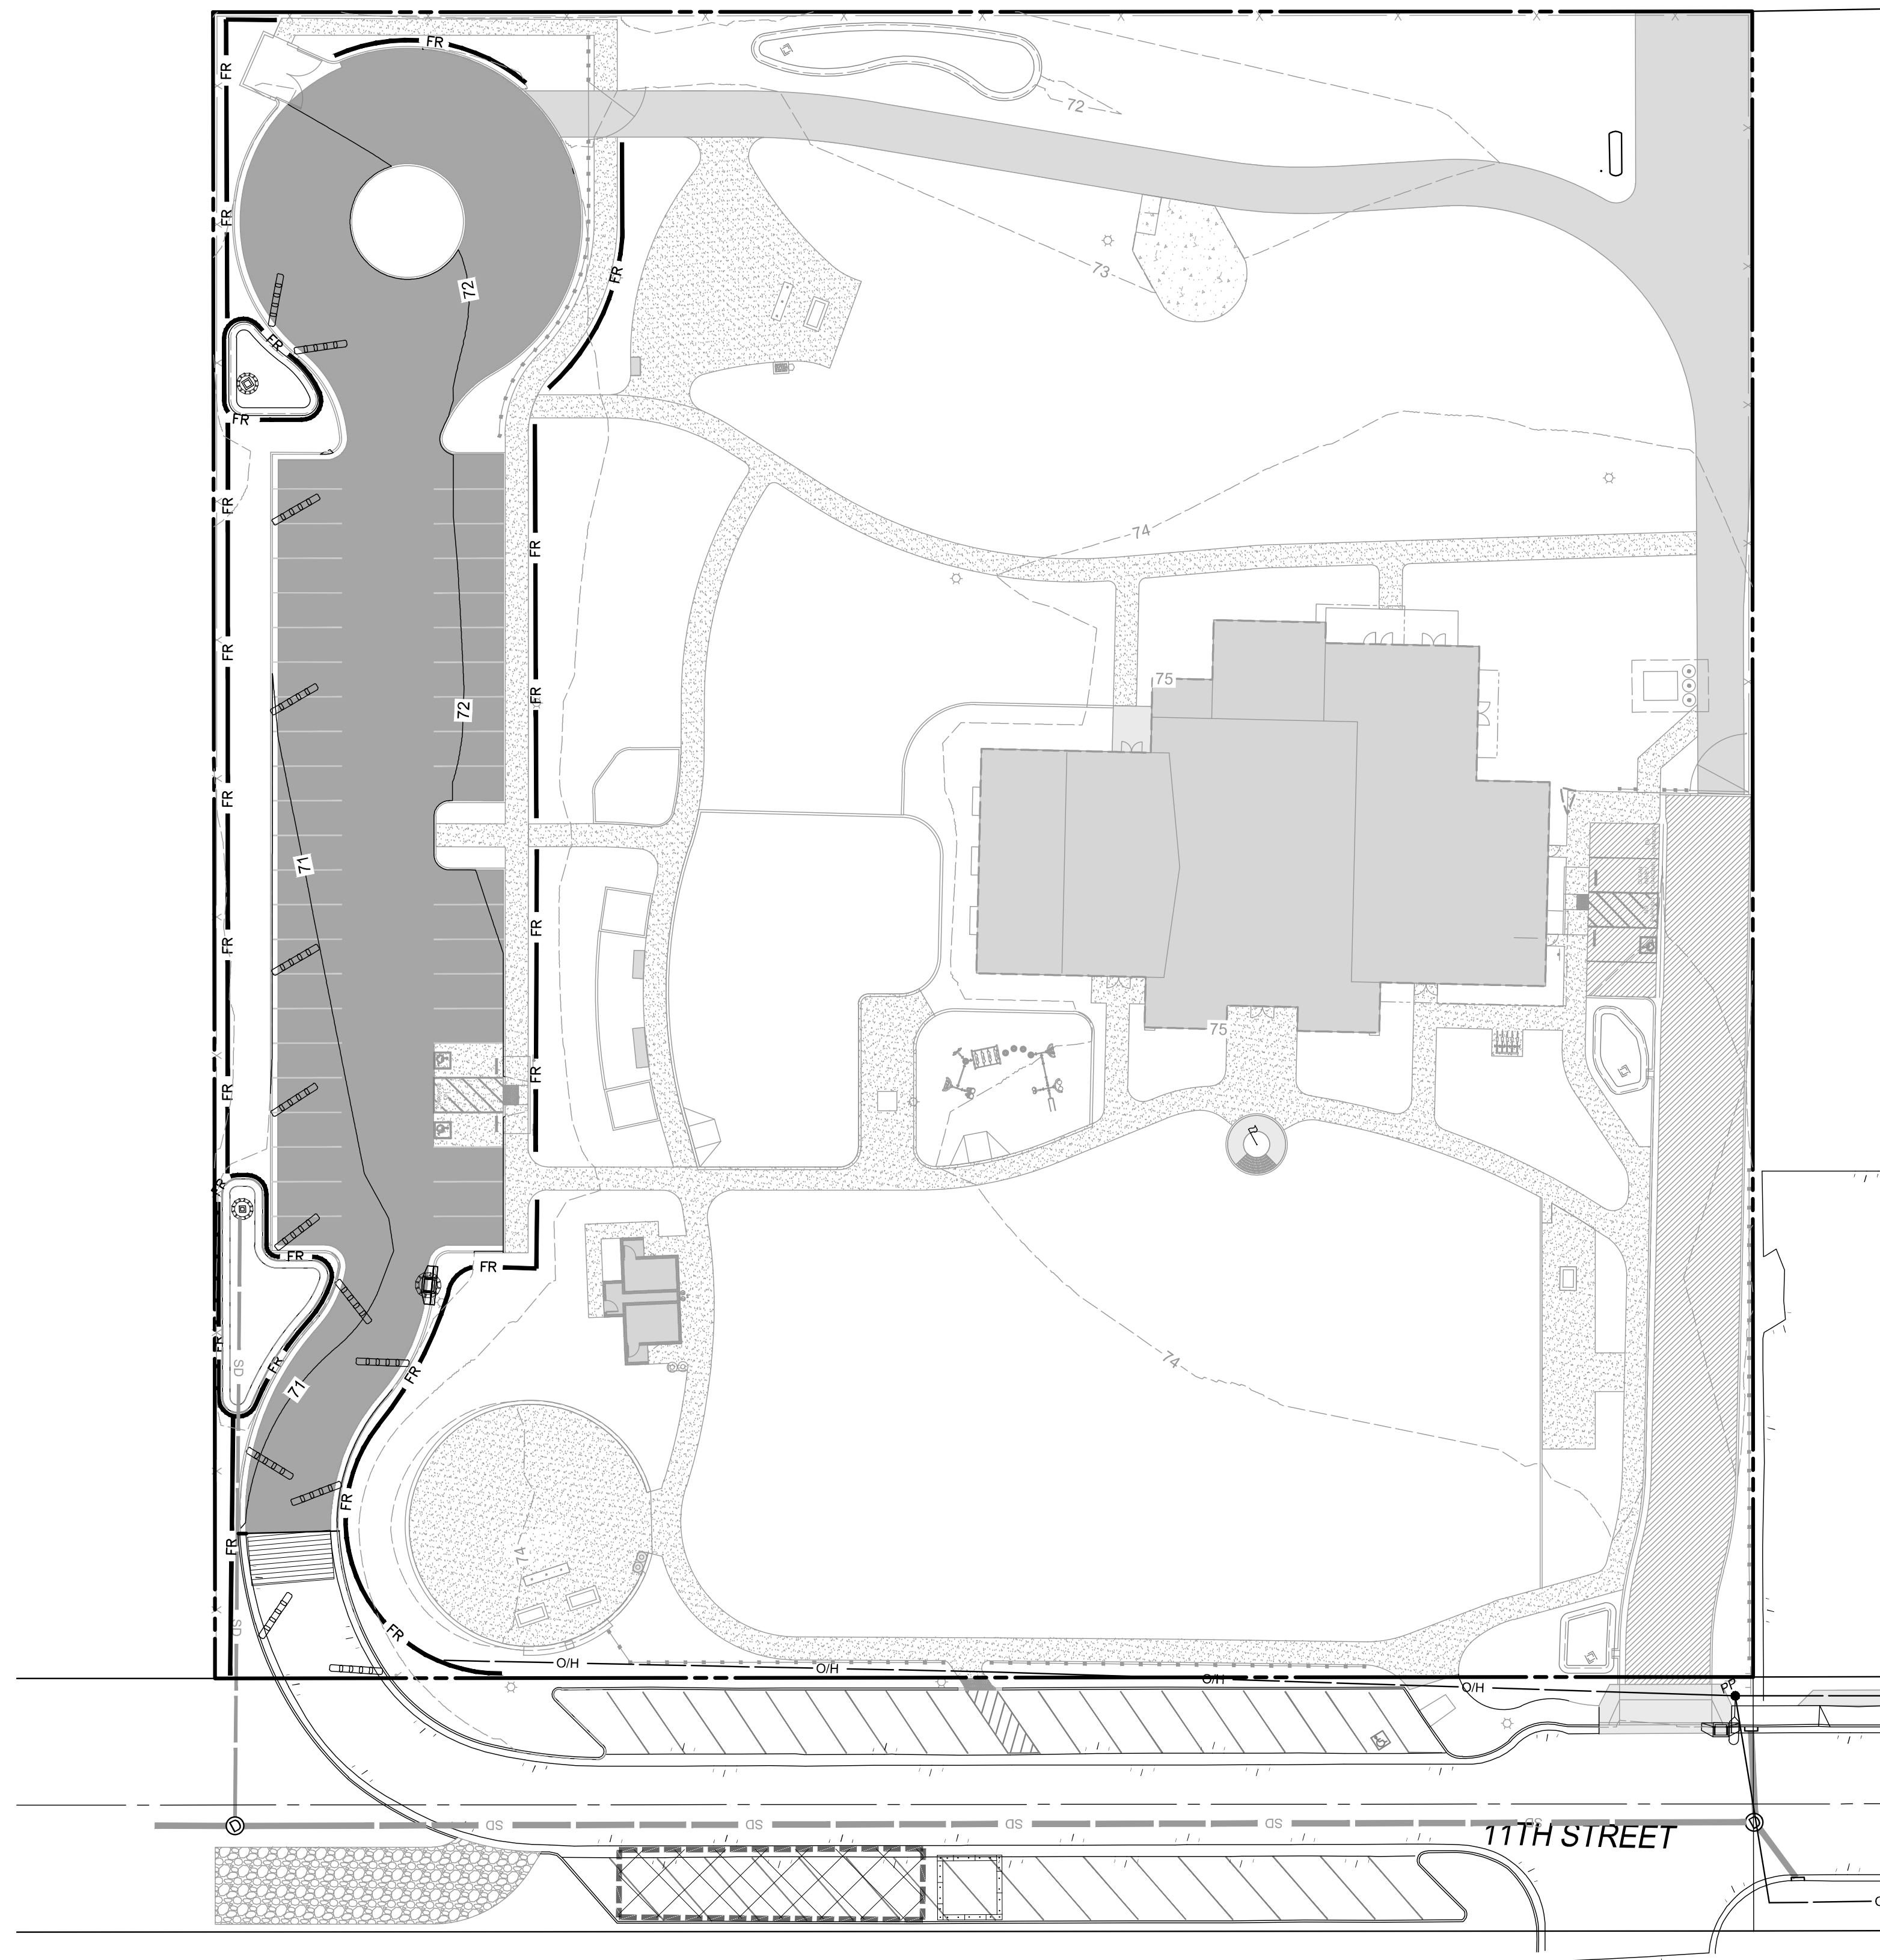

LEGEND:

-  FIBER ROLL IN ACCORDANCE WITH CALTRANS BMP SC-5 AND STANDARD DETAIL T56 (SHEET C-4.1)
-  PROVIDE STABILIZED CONSTRUCTION ENTRANCE/EXIT, IMPLEMENT CALTRANS BMP TC-1 AND STANDARD DETAIL T58 (SHEET C-4.1). LENGTH AND WIDTH OF CONSTRUCTION ENTRANCE CAN BE REDUCED TO ACCOMMODATE SITE CONSTRAINTS
-  TEMPORARY DRAINAGE INLET PROTECTION (TYPE 3A) (GRAVEL BAG BERM) IN ACCORDANCE WITH CALTRANS BMP SC-10 AND STANDARD DETAIL T61, T62 (SHEET C-4.1)
-  TEMPORARY CONCRETE WASHOUT IN ACCORDANCE WITH CALTRANS BMP WM-8 AND STANDARD DETAIL T59 (SHEET C-4.1)
-  CONSTRUCTION STAGING YARD. SEE DETAIL ON SHEET C-4.1

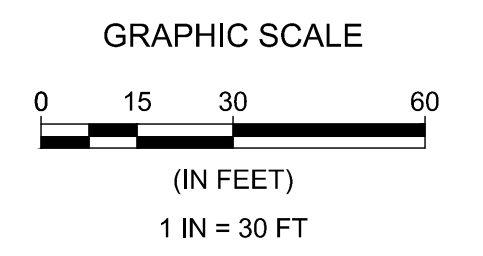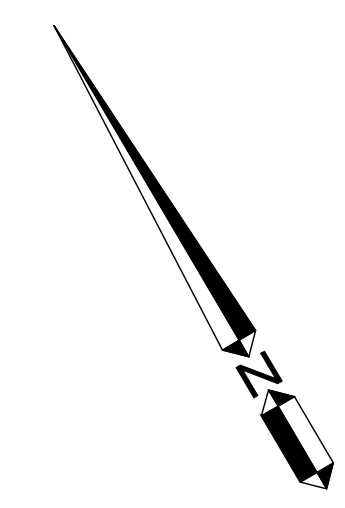


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REVISIONS

DATE: 10/25/2024

PROJECT  
GUADALUPE LEROY PARK  
PARKING LOT UPGRADE

4689 11TH STREET  
GUADALUPE,  
CALIFORNIA 93434

CLIENT  
  
CITY OF GUADALUPE

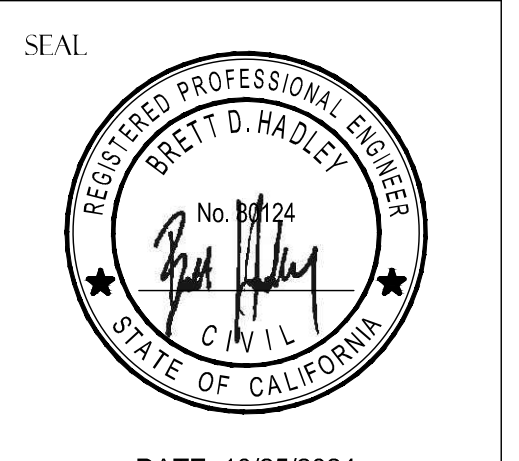SHEET TITLE  
EROSION CONTROL  
PLAN


DATE: 10/25/2024

TECHNICIAN: CPK





PROJECT MANAGER: BDH

JOB NUMBER: 827

SHEET NUMBER  
C-4.0

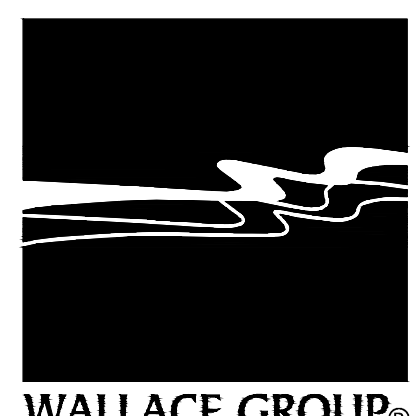


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**Stockpile Management**

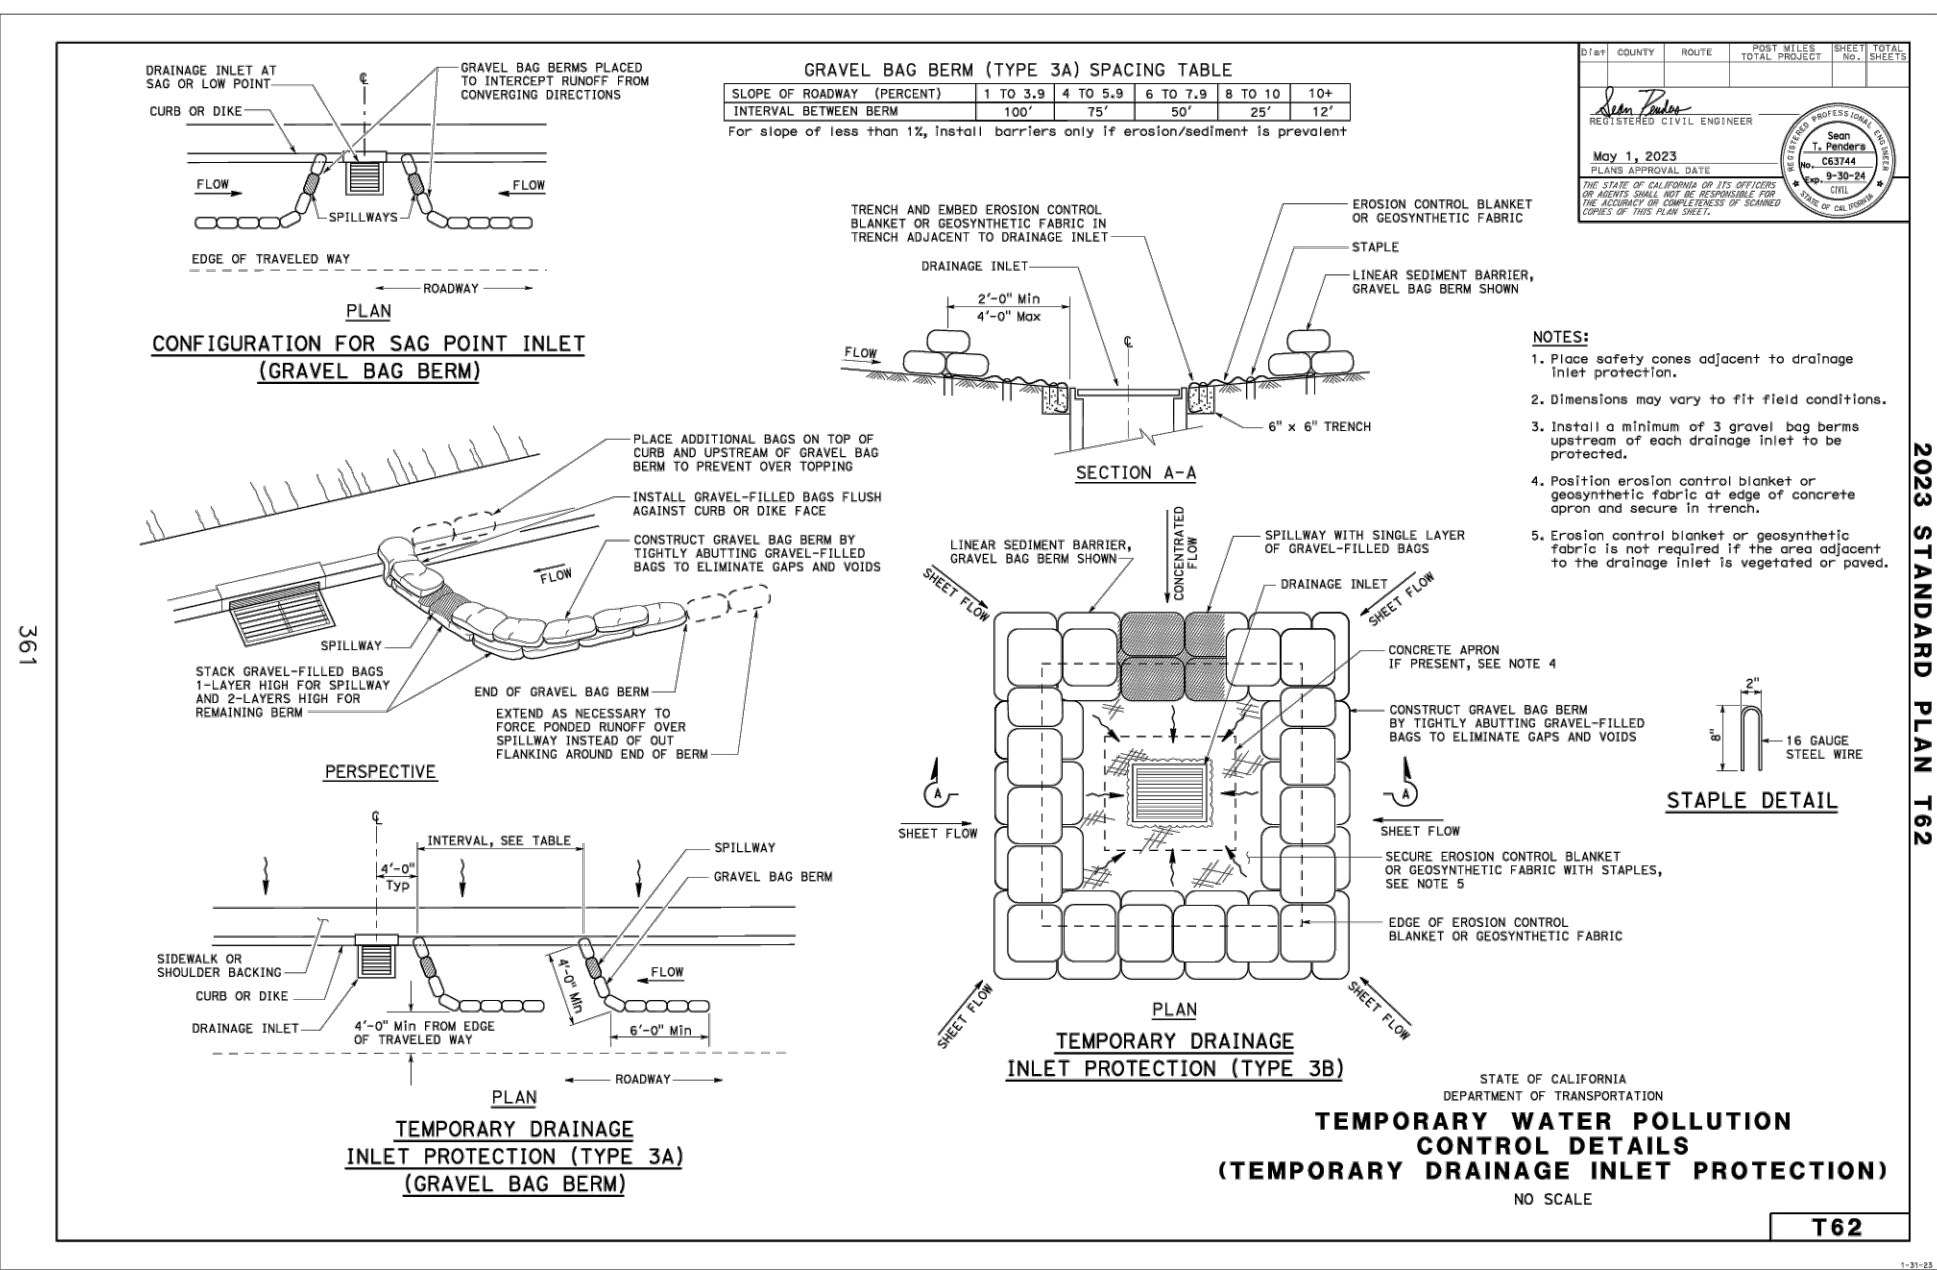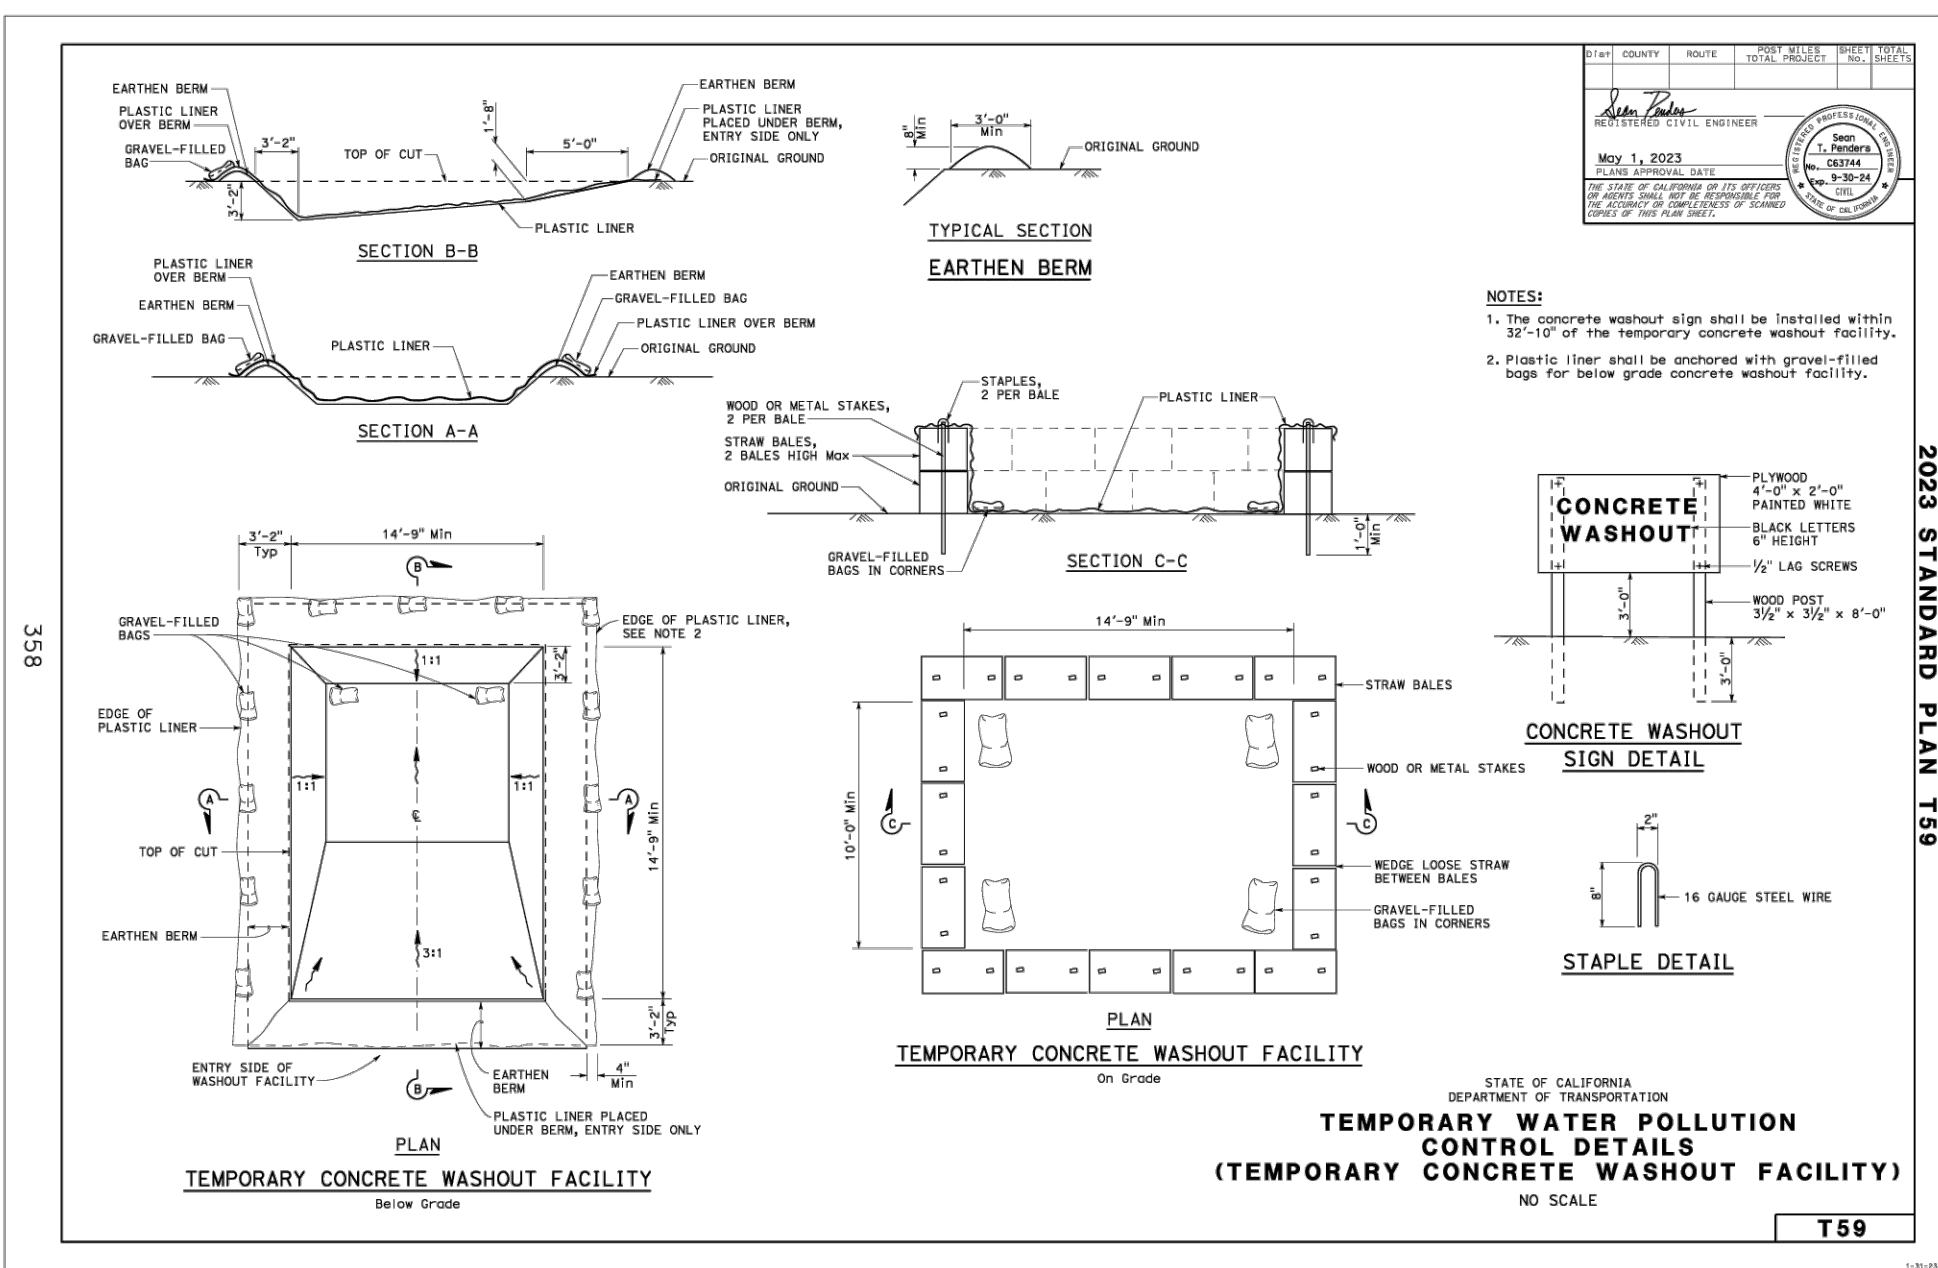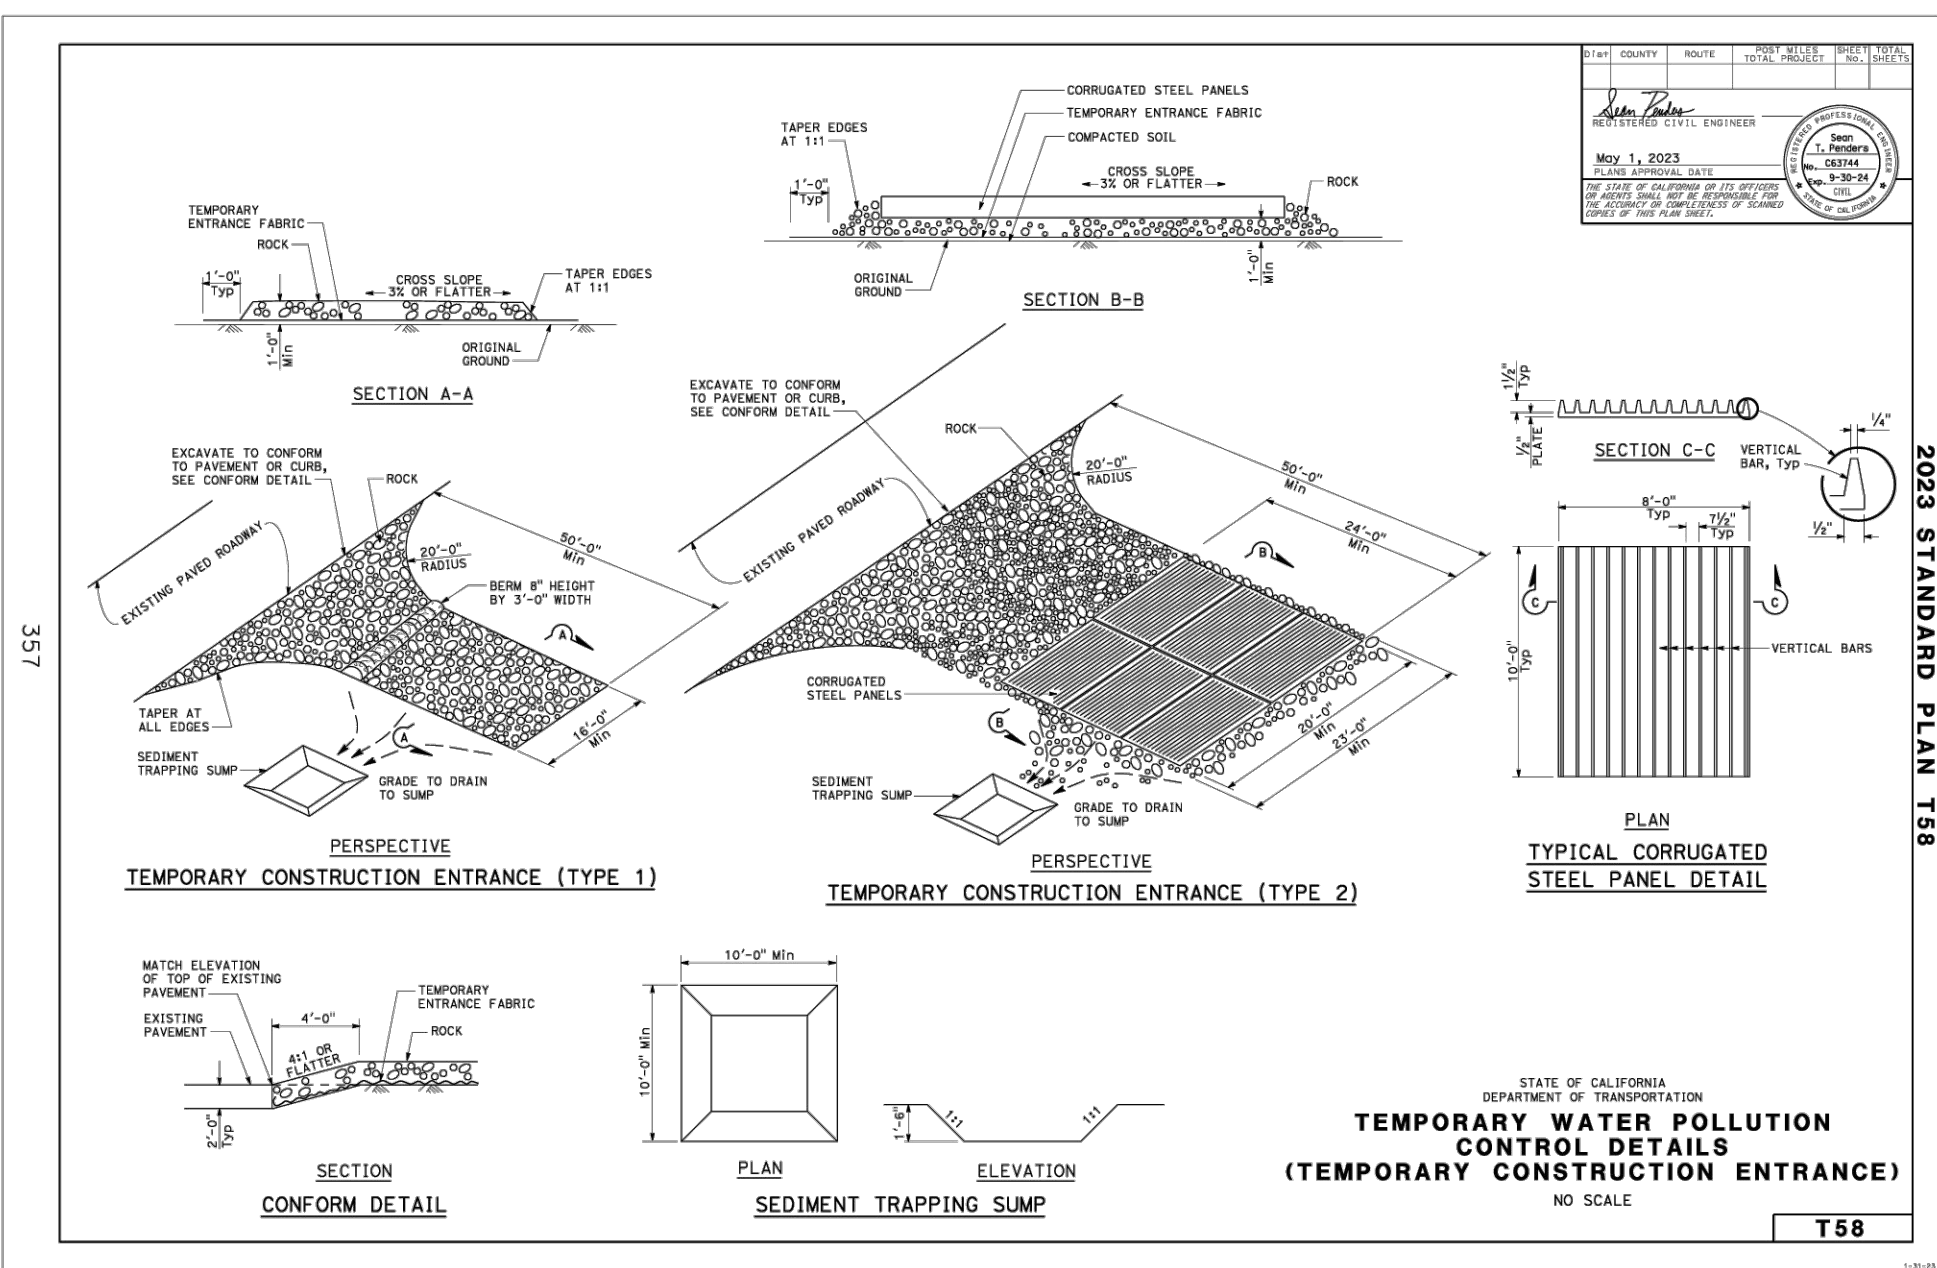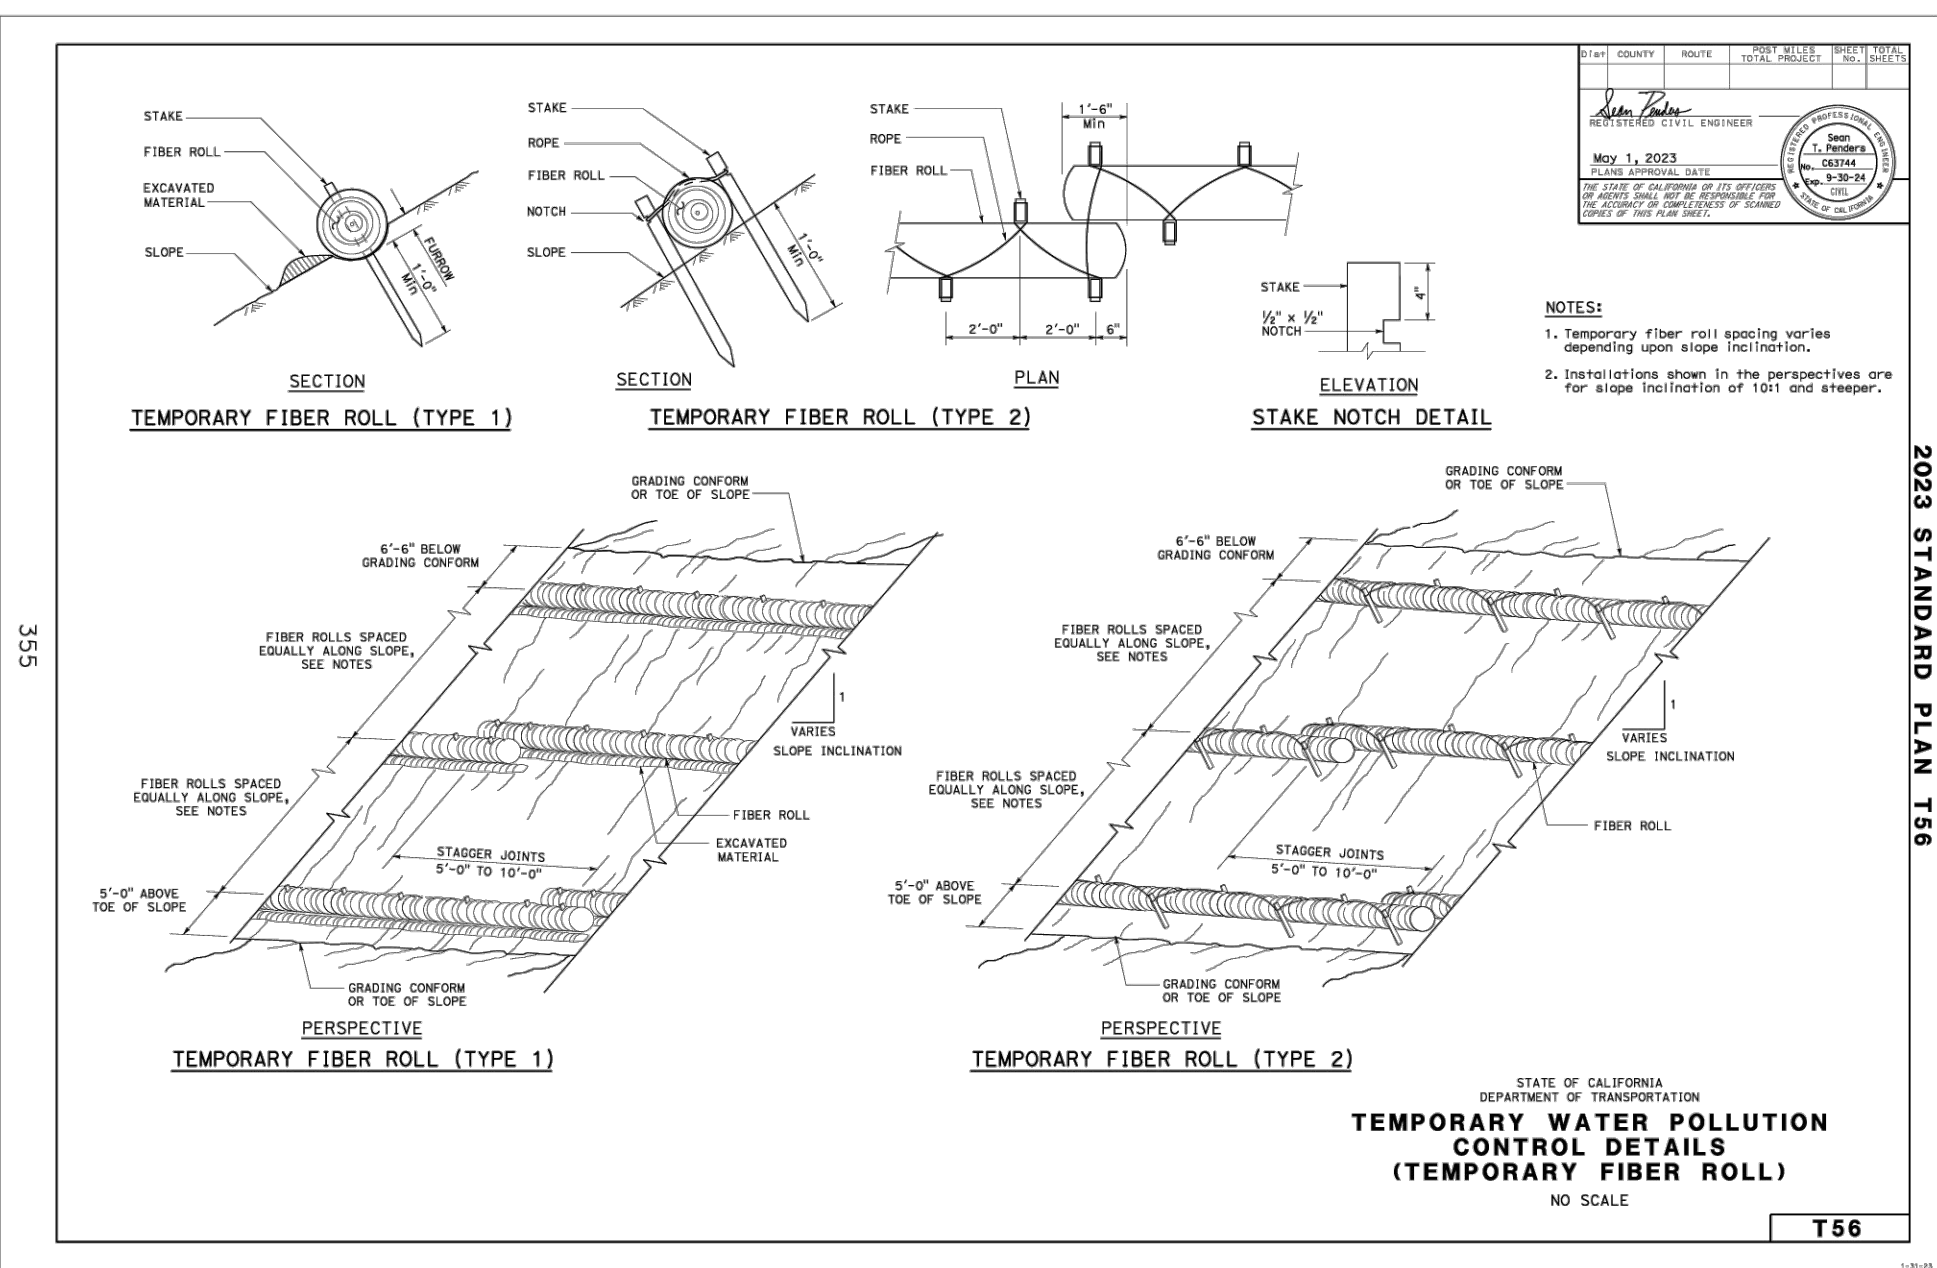**WM-3**



BMP Objectives	
Soil Stabilization	<input type="checkbox"/>
Sediment Control	<input type="checkbox"/>
Tracking Control	<input type="checkbox"/>
Wind Erosion Control	<input type="checkbox"/>
Non-Stormwater Management	<input type="checkbox"/>
Materials and Waste Management	<input checked="" type="checkbox"/>

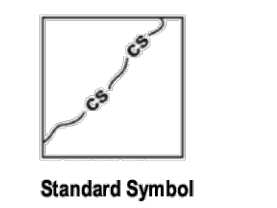**Definition and Purpose**

Stockpile management procedures and practices are designed to reduce or eliminate air and storm water pollution from stockpiles of soil, and paving materials such as portland cement concrete (PCC) rubble, asphalt concrete (AC), asphalt concrete rubble, aggregate base, aggregate subbase or pre-mixed aggregate, asphalt binder (so called "cold mix" asphalt) and pressure treated wood.

**Appropriate Applications**

Implemented in all projects that stockpile soil and other materials.

**Limitations**


Use of plastic cover might be restricted depending on the location of the site and regulatory permits.

**Standards and Specifications**

Stockpiles must comply with Standard Specification 13-4.03C (3) Stockpile Management. Protection of stockpiles is a year-round requirement. Locate stockpiles a minimum of 50 ft. away from concentrated flows of storm water, drainage courses, and inlets. Utilize run-on and run-off BMPs to ensure stockpile materials are protected and do not have the potential to discharge material. Implement wind erosion control practices as appropriate on all stockpiled material. For specific information see WE-1, "Wind Erosion Control."

**Sanitary and Septic Waste Management**

**WM-9**

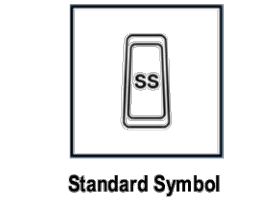

BMP Objectives	
Soil Stabilization	<input type="checkbox"/>
Sediment Control	<input type="checkbox"/>
Tracking Control	<input type="checkbox"/>
Wind Erosion Control	<input type="checkbox"/>
Non-Stormwater Management	<input checked="" type="checkbox"/>
Materials and Waste Management	<input checked="" type="checkbox"/>

**Definition and Purpose**

Procedures and practices to minimize or eliminate the discharge of construction site sanitary and septic waste materials to the storm drain system or to receiving waters.

**Appropriate Applications**


Sanitary/septic waste management practices are implemented on all construction sites that use temporary or portable sanitary and septic waste systems.

**Limitations**

None identified.

**Standards and Specifications**

**Education**  
Educate employees, subcontractors, and suppliers on sanitary and septic waste storage and disposal procedures. Educate employees, subcontractors, and suppliers of potential dangers to humans and the environment from sanitary/septic wastes. Instruct employees, subcontractors, and suppliers in identification of sanitary/septic waste. Hold regular meetings to discuss and reinforce disposal procedures (incorporate into regular safety meetings and taglites). Establish a continuing education program to indoctrinate new employees.

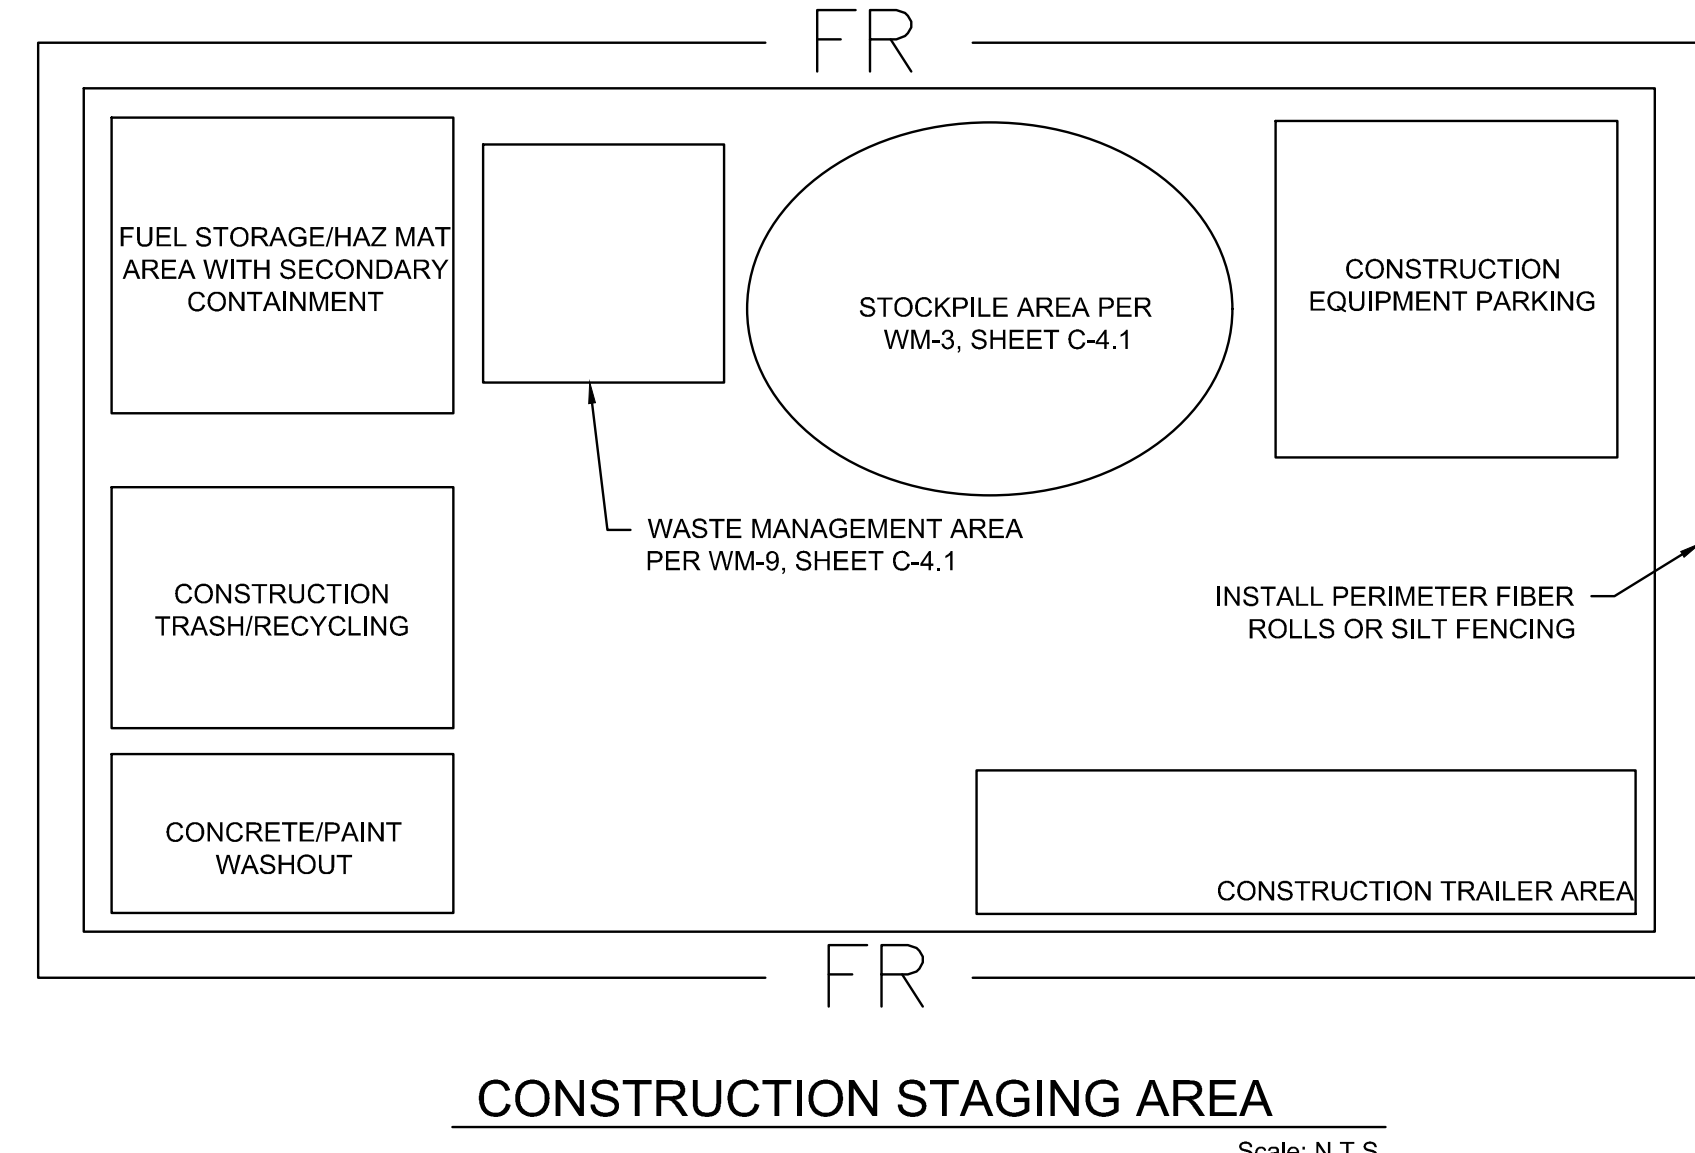

**GENERAL NOTES**

- CALTRANS CONSTRUCTION SITE BEST MANAGEMENT PRACTICES (BMP) MANUAL (DATED MAY 2017) "FACT SHEETS" SHOWN ON THIS SHEET ARE FOR REFERENCE ONLY.
- IT IS THE CONTRACTOR'S RESPONSIBILITY TO REFER TO ORIGINAL CALTRANS CONSTRUCTION SITE BMP MANUAL (MAY 2017) FOR ENTIRE "FACT SHEET" INFORMATION AND DOCUMENTATION.

REVISIONS

NO.	DESCRIPTION

SEAL



DATE: 10/25/2024

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CLIENT

CITY OF GUADALUPE

SHEET TITLE  
EROSION CONTROL  
DETAILS

DATE: 10/25/2024

TECHNICIAN: CPK

PROJECT MANAGER: BDH

JOB NUMBER: 827

SHEET NUMBER  
C-41